Samuels Elementary School Learning Landscape Playground Improvements 15 April, 2009

THIS MAP LEF BLANK INTENTIONALLY

GENERAL NOTES (ALL CONSTRUCTION)

- 1. THE INFORMATION SHOWN ON THESE DRAWINGS CONCERNING TYPE AND LOCATION OF UNDERGROUND AND OTHER UTILITIES IS NOT GUARANTEED TO BE ACCURATE OR ALL INCLUSIVE. THE CONTRACTOR IS RESPONSIBLE FOR MAKING HIS OWN DETERMINATIONS AS TO THE TYPE AND LOCATION OF UNDERGROUND AND OTHER UTILITIES AS MAY BE NECESSARY TO AVOID DAMAGE THERETO. THE CONTRACTORS SHALL NOTIFY THE UTILITY COMPANIES IN ADVANCE OF THEIR CONSTRUCTION OPERATION TO ENABLE THEM TO FIELD LOCATE THEIR UTILITIES.
- 2. THE CONTRACTOR SHALL VERIFY LOCATIONS OF ALL EXISTING UTILITIES AND REPORT FINDINGS TO THE OWNER PRIOR TO PROCEEDING WITH RELATED CONSTRUCTION. IT SHALL BE THE CONTRACTOR'S RESPONSIBILITY TO SATISFY HIMSELF THAT ALL EXISTING UTILITIES, WHETHER SHOWN ON THESE PLANS OR NOT, HAVE BEEN PROPERLY LOCATED. THE CONTRACTOR SHALL ASSUME FULL RESPONSIBILITY FOR THE PROTECTION OF UTILITIES AFFECTED BY THE EXECUTION OF THIS CONTRACT. THE CONTRACTOR SHALL BE RESPONSIBLE FOR CONTACTING THE AFFECTED UTILITY COMPANY AND FOR THE COORDINATION OF ALL WORK IN THE PROXIMITY OF THE UTILITIES.
- 3. IN ADVANCE OF NEW UTILITY CONSTRUCTION, THE CONTRACTOR IS REQUIRED TO POTHOLE ALL UTILITIES WHICH MAY BE IMPACTED BY THE PROJECT. ONCE EXPOSED, THE CONTRACTOR SHALL VERIFY THE VERTICAL AND HORIZONTAL LOCATIONS. THE CONTRACTOR SHALL NOTIFY THE OWNER OF THE LOCATIONS AND ANY POTENTIAL CONFLICTS. NO CONTRACTOR CLAIMS FOR EXTRA COMPENSATION DUE TO DELAYS WILL BE GRANTED TO THE CONTRACTOR FOR REDESIGN TIME NECESSITATED BY CHANGES IN ACTUAL LOCATIONS DUE TO HIS LACK OF FIELD VERIFICATION. IF THE CONTRACTOR HAS TO REDO CONSTRUCTION TO AVOID UTILITY CONFLICTS DUE TO HIS FAILURE TO POTHOLE EXISTING STRUCTURES IN ADVANCE OF NEW CONSTRUCTION, NO EXTRA COMPENSATION WILL BE GRANTED.
- 4. THE CONTRACTOR SHALL BE RESPONSIBLE FOR RESTORING ALL SURFACES AND RELATED STRUCTURES SUCH AS DRIVEWAYS, CURBS, GUTTERS, WALKS, AND BITUMINOUS PAVEMENTS TO ORIGINAL CONDITIONS (OR BETTER) AND GRADES, UNLESS DESIGNATED OTHERWISE ON THE DRAWINGS. THE OWNER OR OWNER'S REPRESENTATIVE AND THE CONTRACTOR SHALL TOGETHER COORDINATE THE DOCUMENTATION OF EXISTING GRADES AND OTHER INFORMATION PRIOR TO ALL CONSTRUCTION ACTIVITIES
- 5. THE CONTRACTOR SHALL CONTACT THE UTILITY NOTIFICATION CENTER OF COLORADO (PHONE 1-800-922-1987) FOR THE MARKING OF UNDERGROUND UTILITIES AT LEAST 48 HOURS PRIOR TO CONSTRUCTION. THE CONTRACTOR SHALL TAKE PRECAUTIONARY MEASURES TO PROTECT ALL UTILITY LINES SHOWN AND OTHER UTILITY LINES OTHERWISE LOCATED.
- 6. THE OWNER SHALL PROVIDE THE CONTRACTOR WITH A COMPLETE AND UPDATED SET OF CONSTRUCTION DRAWINGS. THESE DRAWINGS, AND ANY REQUIRED PERMITS, SHALL BE AT THE PROJECT SITE AT ALL TIMES. IF NO PLANS APPEAR ON THE PROJECT SITE, CONSTRUCTION ACTIVITIES MAY BE HALTED AT THE DISCRETION OF THE OWNER.
- BEFORE WORK BEGINS, THE CONTRACTOR SHALL OBTAIN, AT HIS OWN EXPENSE, ALL APPLICABLE CODES, LICENSES, STANDARDS, SPECIFICATIONS, PERMITS, BONDS, ETC. WHICH ARE NECESSARY TO PERFORM THE PROPOSED WORK AND MUST NOTIFY THE REQUIRED PARTIES AT LEAST 24 HOURS IN ADVANCE OF COMMENCING CONSTRUCTION ACTIVITIES.
- 8. ALL SURPLUS MATERIAL, TOOLS, AND TEMPORARY STRUCTURES, FURNISHED BY THE CONTRACTOR, SHALL BE REMOVED FROM THE PROJECT SITE BY THE CONTRACTOR. ALL DEBRIS AND RUBBISH CAUSED BY THE OPERATIONS OF THE CONTRACTOR SHALL BE REMOVED, AND THE AREA OCCUPIED DURING CONSTRUCTION ACTIVITIES SHALL BE RESTORED TO ITS ORIGINAL CONDITION, WITHIN 48 HOURS OF PROJECT COMPLETION.
- 9. THE CONTRACTOR IS RESPONSIBLE FOR COORDINATING AND SCHEDULING RESOLUTION OF ANY
- CONFLICTS BETWEEN THE PROPOSED CONSTRUCTION AND EXISTING FACILITIES.

 10. EXISTING AND PROPOSED MANHOLE RIM ELEVATIONS AND VALVE BOXES SHALL BE ADJUSTED TO FINAL
- ANY CONSTRUCTION RELATED TO EXISTING UTILITIES SHALL BE DONE IN A WAY SO AS TO MINIMIZE DISRUPTION IN SERVICE TO EXISTING USERS.
- 12. ANY CONSTRUCTION DEBRIS OR MUD DROPPED INTO MANHOLES, INLETS, PIPES OR TRACKED ONTO EXISTING ROADWAYS SHALL BE REMOVED IMMEDIATELY BY THE CONTRACTOR. THE CONTRACTOR SHALL REPAIR ANY EXCAVATIONS OR PAVEMENT FAILURES CAUSED BY HIS CONSTRUCTION. THE CONTRACTOR SHALL PROPERLY BARRICADE THE CONSTRUCTION SITE UNTIL CONSTRUCTION IS COMPLETE.
- 13. THE CONTRACTOR SHALL BE SOLELY AND COMPLETELY RESPONSIBLE FOR CONDITIONS AT AND ADJACENT TO THE JOB SITE, INCLUDING SAFETY OF ALL PERSONS AND PROPERTY DURING PERFORMANCE OF THE WORK. THE CONTRACTOR SHALL PROVIDE ALL LIGHTS, SIGNS, BARRICADES, FLAGMEN, OR OTHER DEVICES NECESSARY TO PROVIDE FOR PUBLIC SAFETY. THIS REQUIREMENT SHALL APPLY CONTINUOUSLY AND NOT BE LIMITED TO NORMAL WORKING HOURS.
- 14. THE CONTRACTOR SHALL BE RESPONSIBLE FOR THE REMOVAL AND REPLACEMENT OF ALL MATERIALS WITHIN DEDICATED RIGHT-OF-WAYS AND ALL MATERIALS AND WORKMANSHIP SHALL MEET THE ROADWAY DESIGN AND CONSTRUCTION STANDARDS OF THE APPROPRIATE GOVERNING AGENCY.
- 15. WATER SHALL BE USED AS A DUST PALLIATIVE WHERE REQUIRED. LOCATIONS AND FREQUENCIES SHALL BE TO THE SATISFACTION OF THE ENGINEER. WATER WILL NOT BE PAID FOR SEPARATELY BUT WILL BE INCLUDED IN THE WORK.
- 16. THE CONTRACTOR SHALL PROVIDE ALL LABOR AND MATERIALS TO PERFORM THE WORK. THE OWNER SHALL HIRE A TESTING AGENCY TO PERFORM ALL TESTING AND THE CONTRACTOR SHALL COORDINATE & COOPERATE THIS TESTING WITH HIS WORK. REQUIRED TESTING MUST BE DONE PRIOR TO ACCEPTANCE.
- CONSTRUCTION SHALL BE CONDUCTED SUCH THAT EMERGENCY ACCESS IS MAINTAINED THROUGHOUT THE DURATION OF CONSTRUCTION.
- THE CONTRACTOR SHALL MAINTAIN SIDEWALKS & DRIVES IN CLEAN USABLE CONDITION.
 THE CONTRACTOR SHALL BE RESPONSIBLE FOR NOTIFYING THE OWNER (DENVER PUBLIC SCHOOL, DISTRICT NO. 1) AT LEAST 48 HOURS PRIOR TO START OF ANY CONSTRUCTION. IF WORK IS SUSPENDED
- HOURS PRIOR TO RESTART.

 20. THE CONTRACTOR SHALL BE RESPONSIBLE FOR NOTIFYING THE CITY AND COUNTY OF DENVER FIRE DEPARTMENT OF ALL STREET CLOSINGS AND EXISTING FIRE HYDRANTS TAKEN OUT OF SERVICE AT LEAST 48 HOURS PRIOR TO THE START OF CONSTRUCTION.

FOR ANY PERIOD OF TIME AFTER INITIAL STARTUP, THE CONTRACTOR SHALL NOTIFY THE OWNER 48

CONCRETE CONSTRUCTION NOTES

1. DESIGN REQUIREMENTS AND MATERIAL SPECIFICATIONS SHALL CONFORM TO THE

FOLLOWING REFERENCED CODES:

A. UNIFORM BUILDING CODE

B. ACI-318-99

2. CONCRETE

A. SCHEDULE OF CONCRETE MIXES - SEE WRITTEN SPECIFICATIONS.

B. 28-DAY COMPRESSIVE STRENGTH UNLESS OTHERWISE NOTED.
 C. USE TYPE II CEMENT.

D. WATER/CEMENTIOUS RATIO - SEE WRITTEN SPECIFICATIONS.

E. SPECIFIER MAY ALLOW AN ADJUSTMENT IN SLUMP USING ADMIXTURES TO FACILITATE PLACEMENT SO LONG AS THE W/C OF THE APPROVED MIX DESIGN IS MAINTAINED. F. WRA - WATER REDUCING ADMIXTURE.

G. AGGREGATES SHALL CONFORM TO REQUIREMENTS OF ASTM C-33.

H. THE AIR CONTENT OF AIR-ENTRAINED CONCRETE WHEN SAMPLED FROM THE TRANSPORTATION UNIT AT THE POINT OF DISCHARGE SHALL BE WITHIN A TOLERANCE OF + 1.5 % OF THE SPECIFIED VALUE (ASTM C-94, PARAGRAPH 7.2).

3. REINFORCI

A. ALL REINFORCING STEEL EXCEPT TIES SHALL BE NEW BILLET BARS IN ACCORDANCE WITH ASTM A 615 WITH A MINIMUM YIELD POINT OF

B. ALL TIE REINFORCING STEEL SHALL BE NEW BILLET BARS IN ACCORDANCE

WITH ASTM A 615 WITH A MINIMUM YIELD POINT OF 40,000 PSI.

C. DO NOT WELD OR REBEND ANY BARS WITH A YIELD POINT GREATER THAN

C. DO NOT WELD OR REBEND ANY BARS WITH A YIELD POINT GREATER THAN 40,000 PSI.

D. REINFORCING PROTECTION

i. CONCRETE POURED AGAINST EARTH ----- 3.0 IN. ii. CONCRETE IN FORMS BUT EXPOSED TO EARTH OR WEATHER ---- 2.0 IN.

i. ALL BAR LENGTHS ARE DRAWN TO SCALE UNLESS NOTED OTHERWISE.
ii. ALL SPLICES SHALL BE 36 BAR DIA. WITH A MINIMUM LAP OF 1'-6".

iii.MAKE OUTSIDE BARS CONTINUOUS AROUND CORNERS.
F. DETAIL BARS AND PROVIDE ACCESSORIES NECESSARY TO SUPPORT BARS AT THEIR PROPER POSITIONS ACCORDING TO ACI DETAILING MANUAL, LATEST EDITION.

G. PLACE 2-#4 (1 EA. FACE) WITH 1'-6" PROJECTION AROUND ALL OPENINGS IN CONCRETE.

H. ALL CONCRETE WORK SHALL HAVE NO JOINTS IN A HORIZONTAL PLANE.
 I. FIBER REINFORCEMENT - SEE WRITTEN SPECIFICATIONS.

4. GENERAL

A. PROVIDE SLEEVES FOR ALL PIPES PLACED THROUGH CONCRETE. B. ARCHITECTS APPROVAL MUST BE SECURED FOR ALL SUBSTITUTIONS.

ABBREVIATIONS

BASKETBALL BACKSTOP AND POLE **BOTTOM OF CURB** BOC BOTTOM OF FOOTING BOW **BOTTOM OF WALL BOTTOM OF STEP** BACK OF WALL CL CENTER LINE **EWF** ENGINEERED WOOD FIBER FG FINISH GRADE FINISH GRADE OF EWF FLOWLINE GRADE **GRADE BREAK** HIGH POINT LOW POINT MATCH EXISTING NIC NOT IN CONTRACT ON CENTER PAVEMENT POINT OF BEGINNING TB TETHERBALL POLE TOC TOP OF CURB TOF TOP OF FOOTING TOM TOP OF MULCH (EWF) TOP OF WALL TOP OF STEP TYPICAL

SHEET DESCRIPTION

VICINITY MAP

STRIKE THROUGHS INDICATE SHEETS DELIBERATELY

Denver Public Schools
2800 W. 7th Avenue
Denver, CO 80204

G1.1

GPD Land Design, LLC
4668 S. Xavier Street
Denver, CO 80236
303.788.9604

C0.1 4 C1
C1.1 5 C2
C2.1 6 C3

303.788.9977 (fax) gpdlanddesign.com

CIVIL ENGINEER Brown Civil Engineering

990 S. Public Rd., Suite 2B Lafayette, CO80026 303.551.8910

303.551.8940 (fax) www.BrownCivilEngineering.com

IRRIGATION Christopher Hoy Design Group
DESIGN 1184 W. 111th Place

OWNER

LANDSCAPE

ARCHITECT

1184 W. 111th Place Northglenn, CO 80234

303.451.7986 303.451.7987 (fax) chdg-inc.com G1.1 1 COVER

G1.2 2 SURVEY

C1.1 3 C0.1 HORIZONTAL CONTROL POINTS & NOTES

C0.1 4 C1.1 CIVIL SITE LAYOUT PLAN

C1.1 5 C2.1 GRADING & DRAINAGE PLAN
C2.1 6 C3.0 EROSION CONTROL NOTES
C3.0 7 C3.1 EROSION CONTROL PLAN
C3.1 8 C3.3 EROSION CONTROL DETAILS

C3.1 8 C3.3 EROSION CONTROL DETAILS
C3.3 9 C3.4 EROSION CONTROL DETAILS
C3.4 10 C8.1 DETAILS SHEET

C3.5 11 C8.2 DETAILS SHEET
C3.6 12 C8.3 DETAILS SHEET
L1.1 13 DEMOLITION PLAN

L1.2 14 LANDSCAPE PLAN
L1.3 15 HORIZONTAL SURFACING PLAN

L1.4 16 LAYOUT PLAN L1.5 17 PLANTING PLAN

L1.6 18 STRIPING PLAN

L1.7 19 EGRESS PLAN

L1.8 20 DETAIL CALLOUT

L2.1 21 DETAILS A L2.2 22 DETALS B

L2.3 23 DETALS C L2.4 24 DETAILS D

L2.5 25 DETAILS E L2.6 26 DETAILS F

11.1 27 LANDSCAPE IRRIGATION PLAN

11.2 28 IRRIGATION DETAILS11.3 29 IRRIGATION DETAILS

04.15.09 50% CONSTRUCTION DRAWINGS


NO. DATE DESCRIPTION OF REVISION AUTHORITY MADE APPR'D

DENVER PUBLIC SCHOOLS

SCHOOL DISTRICT NO.1 SITE NO. 148 SCHOOL NO. 296 DENVER, COLORADO

SAMUELS ELEMENTARY SCHOOL LEARNING LANDSCAPE

3985 S Vincennes Ct. Denver, CO 80237

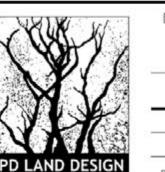


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DENVER PUBLIC SCHOOLS	DESIGNED BY	GPD
DEPARTMENT OF	DRAWN BY	JG
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APPROVED CONTRACT DOCUMENT	DATE	15 APRIL 2009
	SCALE	523


COVER PAGE

G1.1 SHEET

1 Z

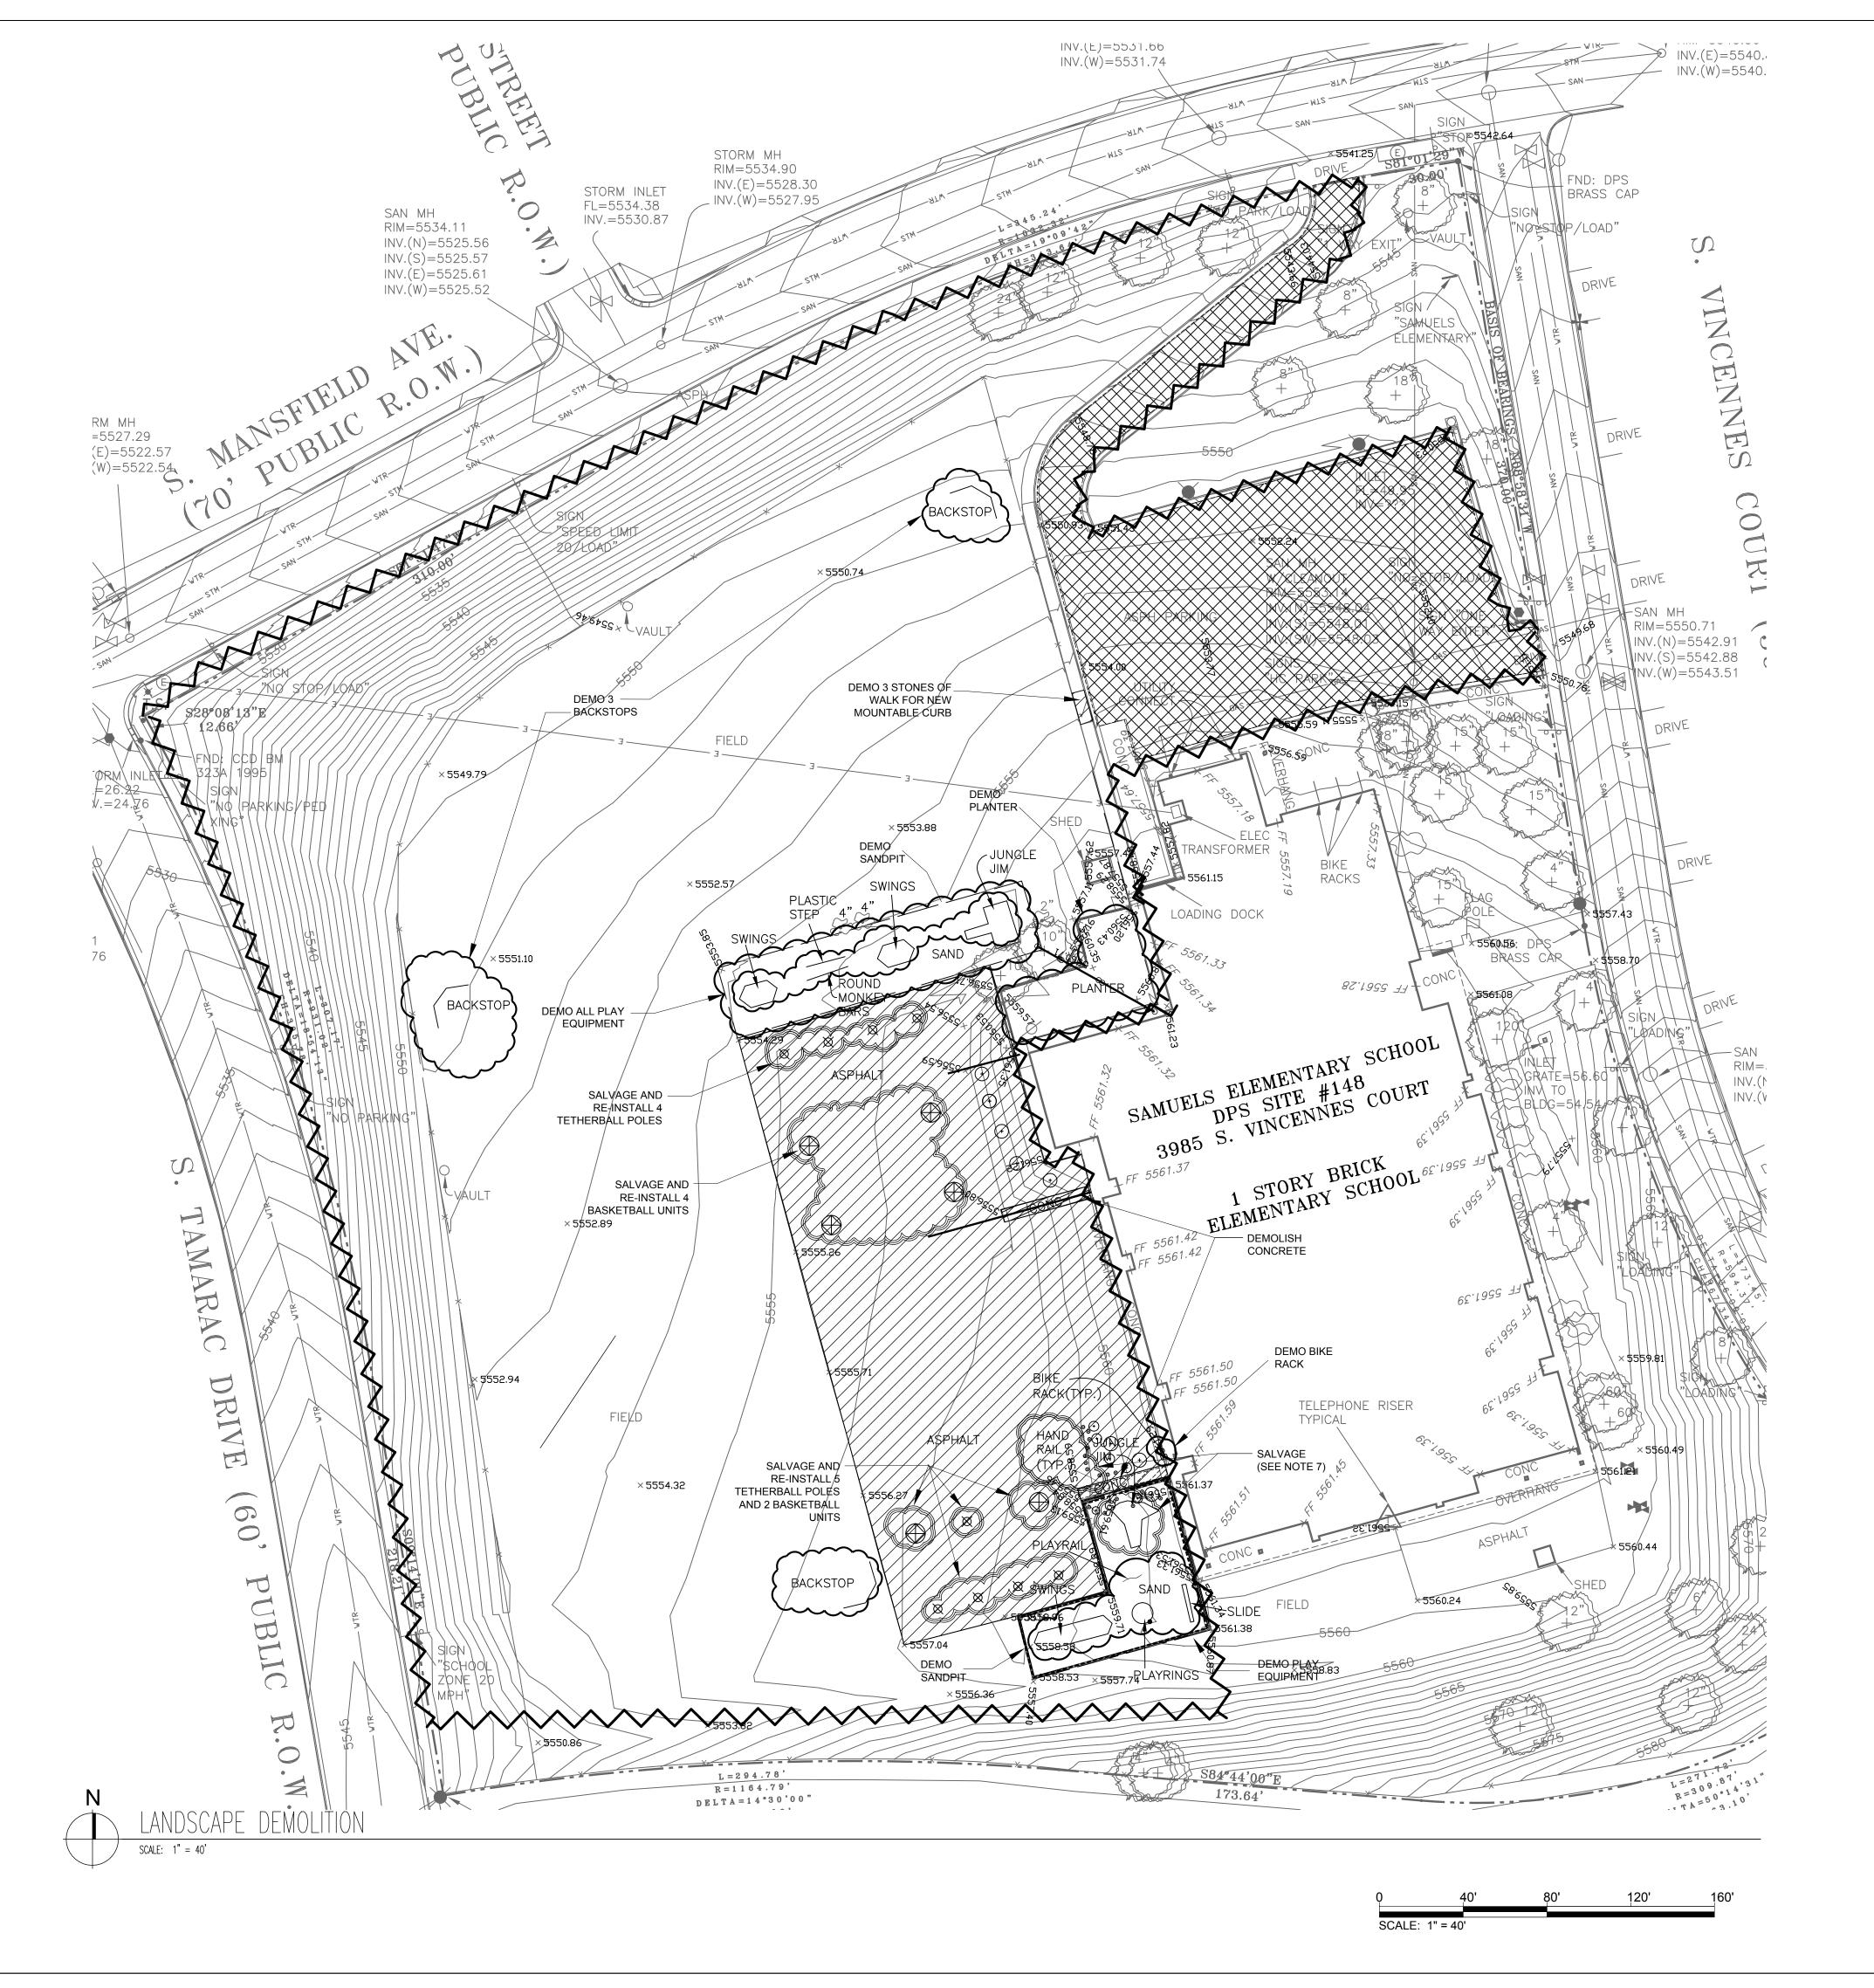

LEGEND

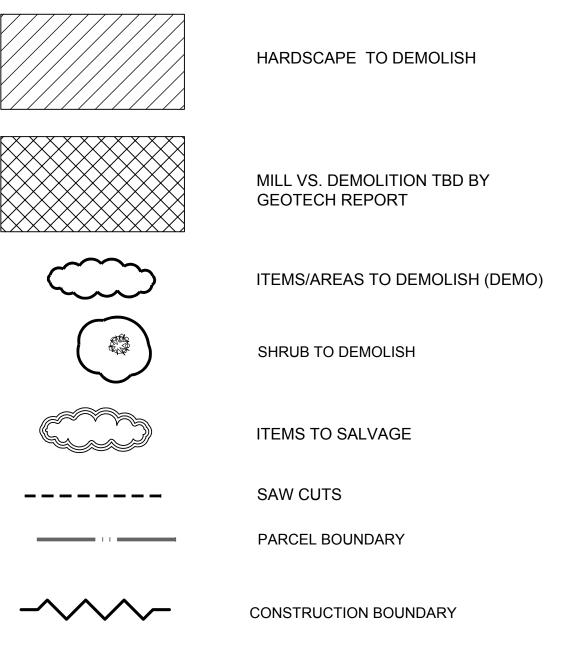

NOTES

- 1. CONCRETE DEMOLITION TO OCCUR AT EXISTING JOINTS WHEN POSSIBLE. WHEN NON-JOINT DEMOLITION REQUIRES CUTTING CONCRETE AND WHEN CUTTING ASPHALT, ALL CUTS TO BE SAW CUT.
- 2. CALL FOR ALL TYPES OF UTILITY LOCATES PRIOR TO ANY EXCAVATION.
- 3. CONTRACTOR IS RESPONSIBLE FOR ALL DEMOLITION, HAULING, AND DISPOSAL. OWNER WILL PROVIDE NONE OF THESE UNLESS SPECIFICALLY NOTED IN THESE DRAWINGS.
- 4. CONTRACTOR TO PROTECT ALL PORTIONS OF THE SITE TO REMAIN, INCLUDING IRRIGATION. PROTECT UTILITY POLE AND STORAGE SHED TO REMAIN.
- 5. CONTRACTOR TO REPAIR AND REPLACE ANY DAMAGE TO EXISTING SITE CONDITIONS CAUSED BY CONSTRUCTION INCLUDING BUT NOT LIMITED TO TURF, ASPHALT, FENCING, IRRIGATION, STRUCTURES, TREES, ETC. TO MEET OR EXCEED EXISTING CONDITIONS AND TO THE OWNER'S SATISFACTION.
- 6. THE CONTRACTOR SHALL PROVIDE FOR UNINTERRUPTED LANDSCAPE WATERING/IRRIGATION THROUGHOUT THE CONSTRUCTION PERIOD UNTIL SITE IS TRANSFERRED TO THE OWNER AND PER WRITTEN SPECIFICATION 01625.
- SALVAGE HANDRAIL AND PAINTED JUNGLE GYM. CONTACT OWNER FOR DISPOSITION INSTRUCTIONS.

CALL UTILITY NOTIFICATION CENTER OF COLORADO

1-800-922-1987

CALL 2-BUSINESS DAYS IN ADVANCE BEFORE YOU DIG, GRADE, OR EXCAVATE FOR THE MARKING OF UNDERGROUND MEMBER UTILITIES.

NOTE TO CONTRACTOR:

ALL EXISTING UTILITIES SHOWN ON THESE PLANS AE APPROXIMATE BASED ON THE BEST AVAILABLE INFORMATION AND FIELD OBSERVATIONS. THE ACTUAL LOCATION OF THESE UTILITIES MUST BE VERIFIED IN THE FIELD PRIOR TO ANY CONSTRUCTION SINCE THE ACTUAL LOCATIONS MAY VARY FROM WHERE SHOWN ON THESE PLANS. CONTRACTOR RESPONSIBLE FOR UTILITY LOCATE.


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			SCHOOL DIST	RICT NO.1	DEPARTMENT SITE NO. 148	OF FACILITIES N SCHOOL NO. :		VER, COL	ORADO			
	SAMUELS ELEMENTARY SCHOOL LEARNING LANDSCAPE											
				3985 S Vincennes Ct. Denver, CO 80237								
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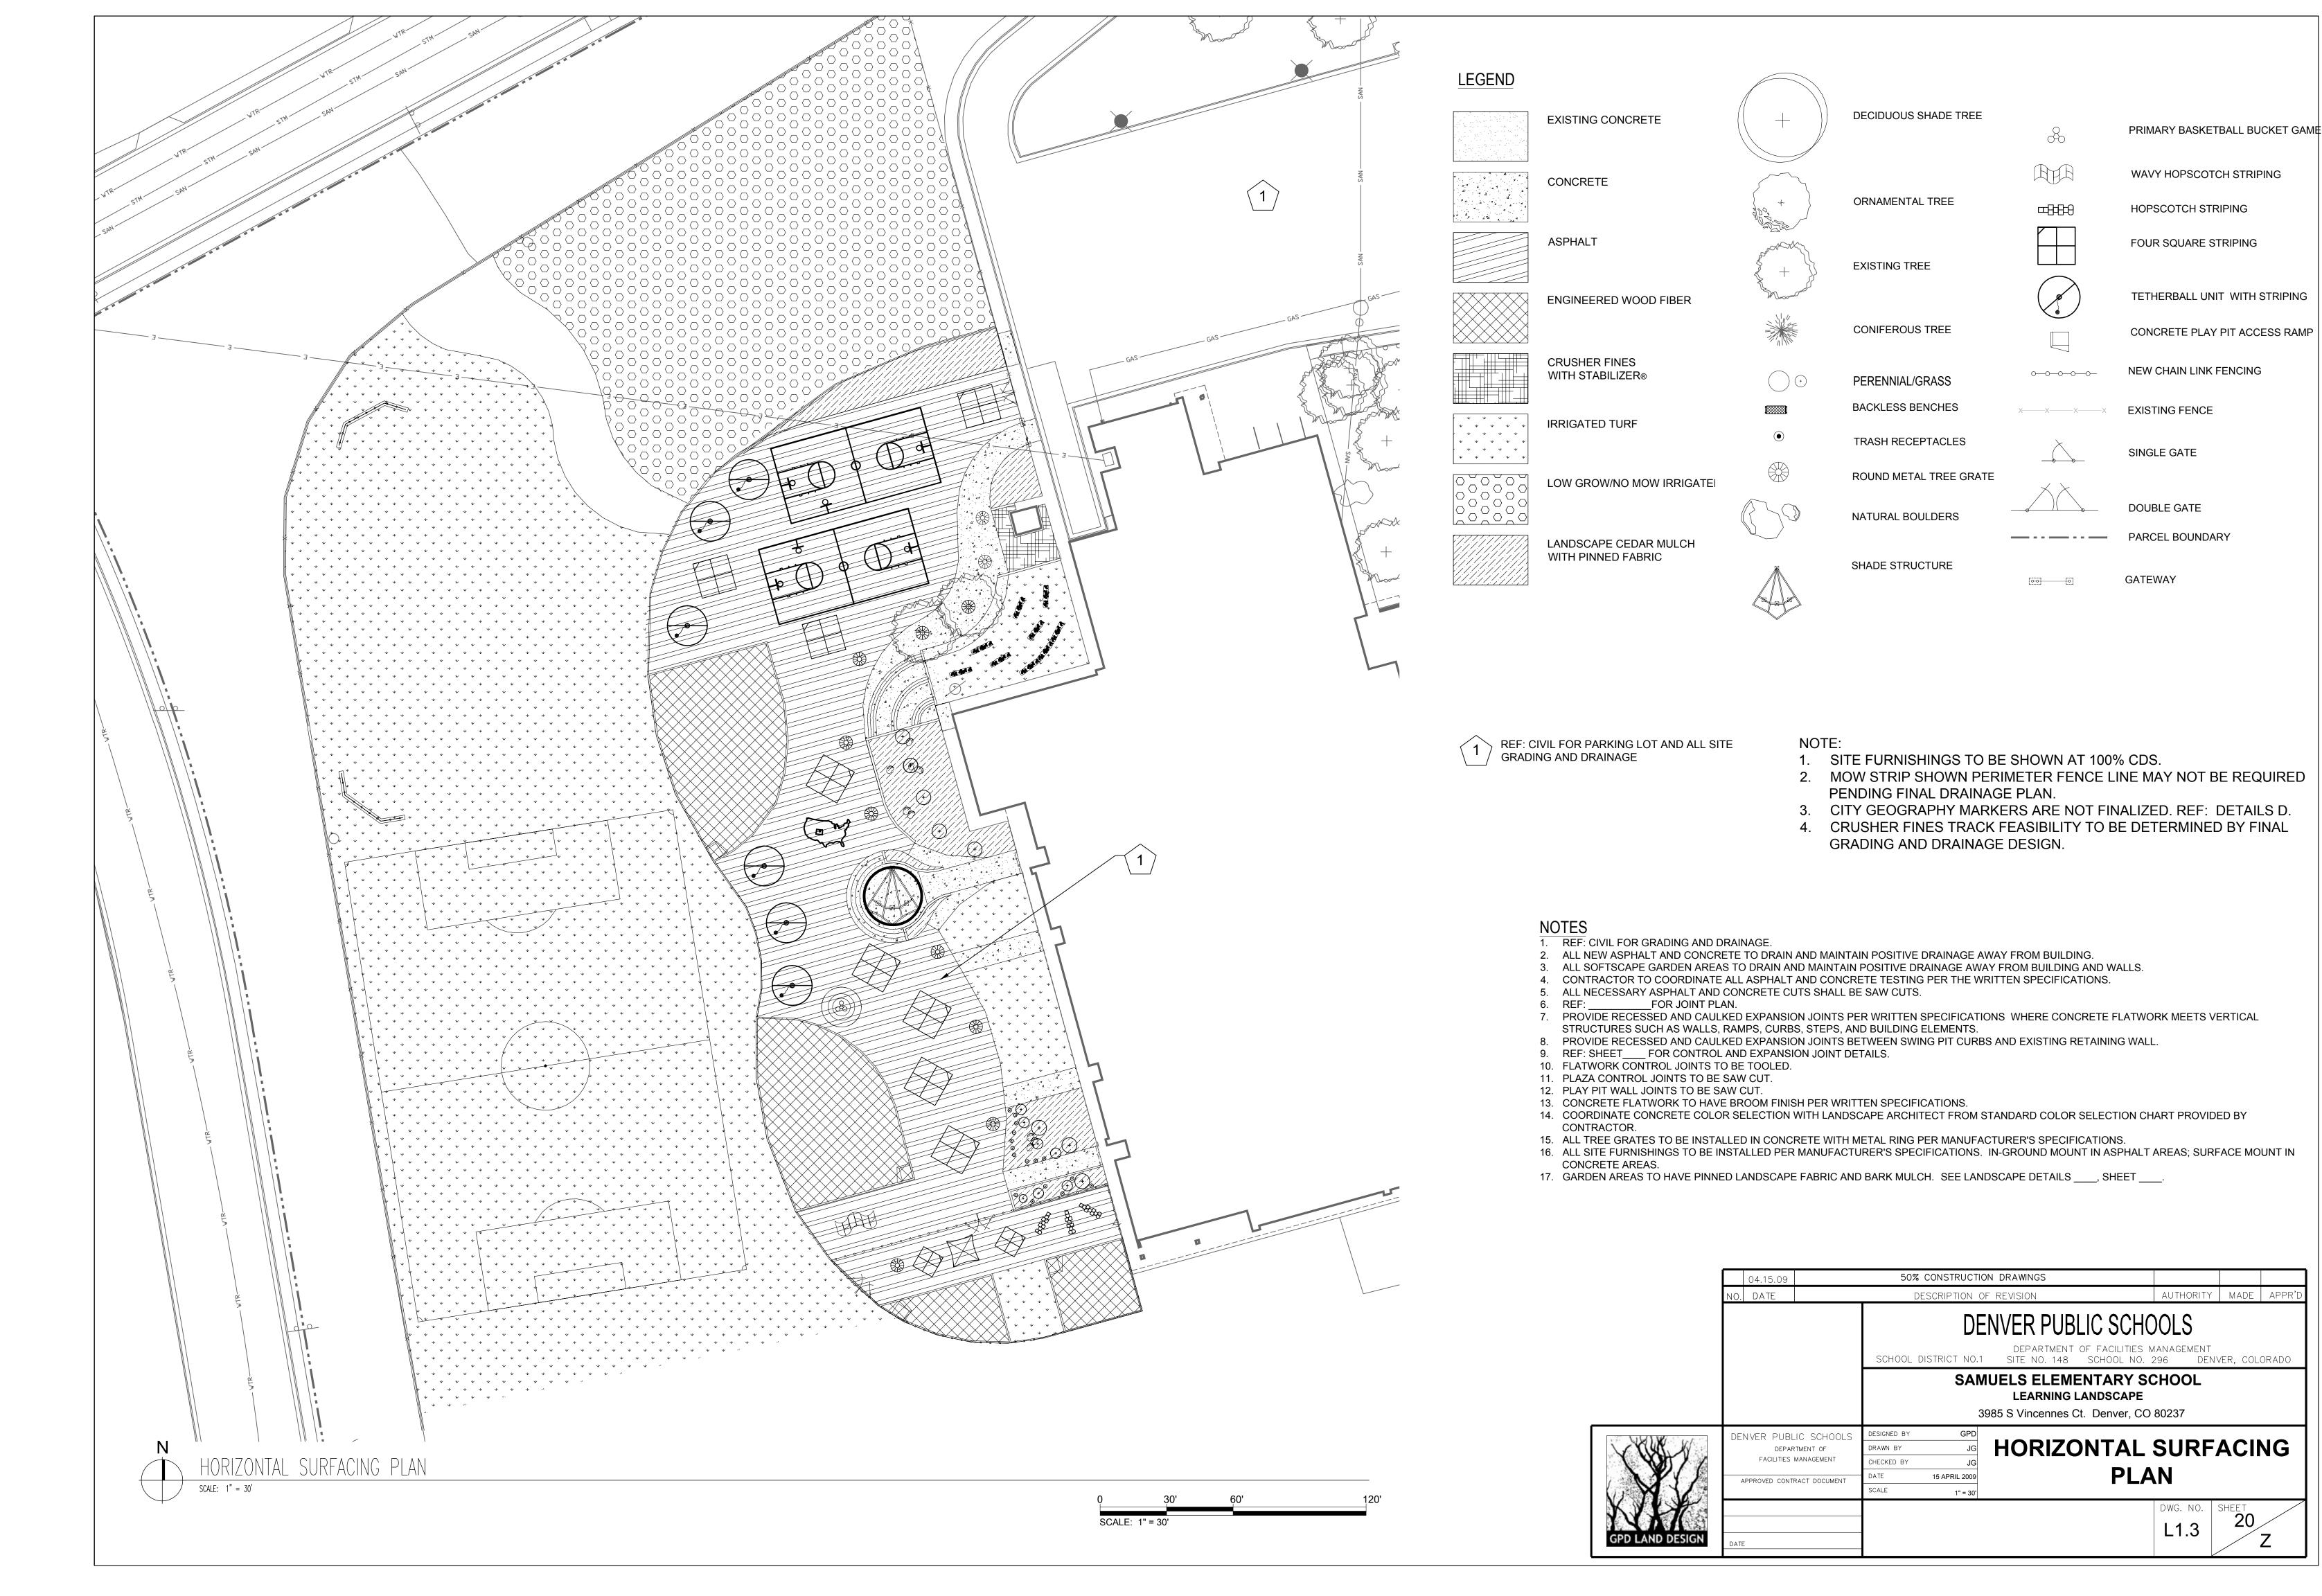


DENVER PUBLIC SCHOOLS	DESIGNED BY	PD
DEPARTMENT OF	DRAWN BY	JG
FACILITIES MANAGEMENT	CHECKED BY	JG
APPROVED CONTRACT DOCUMENT	DATE 15 APRIL 2	2009
	SCALE 1" =	= 30'

DEMOLITION PLAN

DWG. NO. SHEET 20 Z



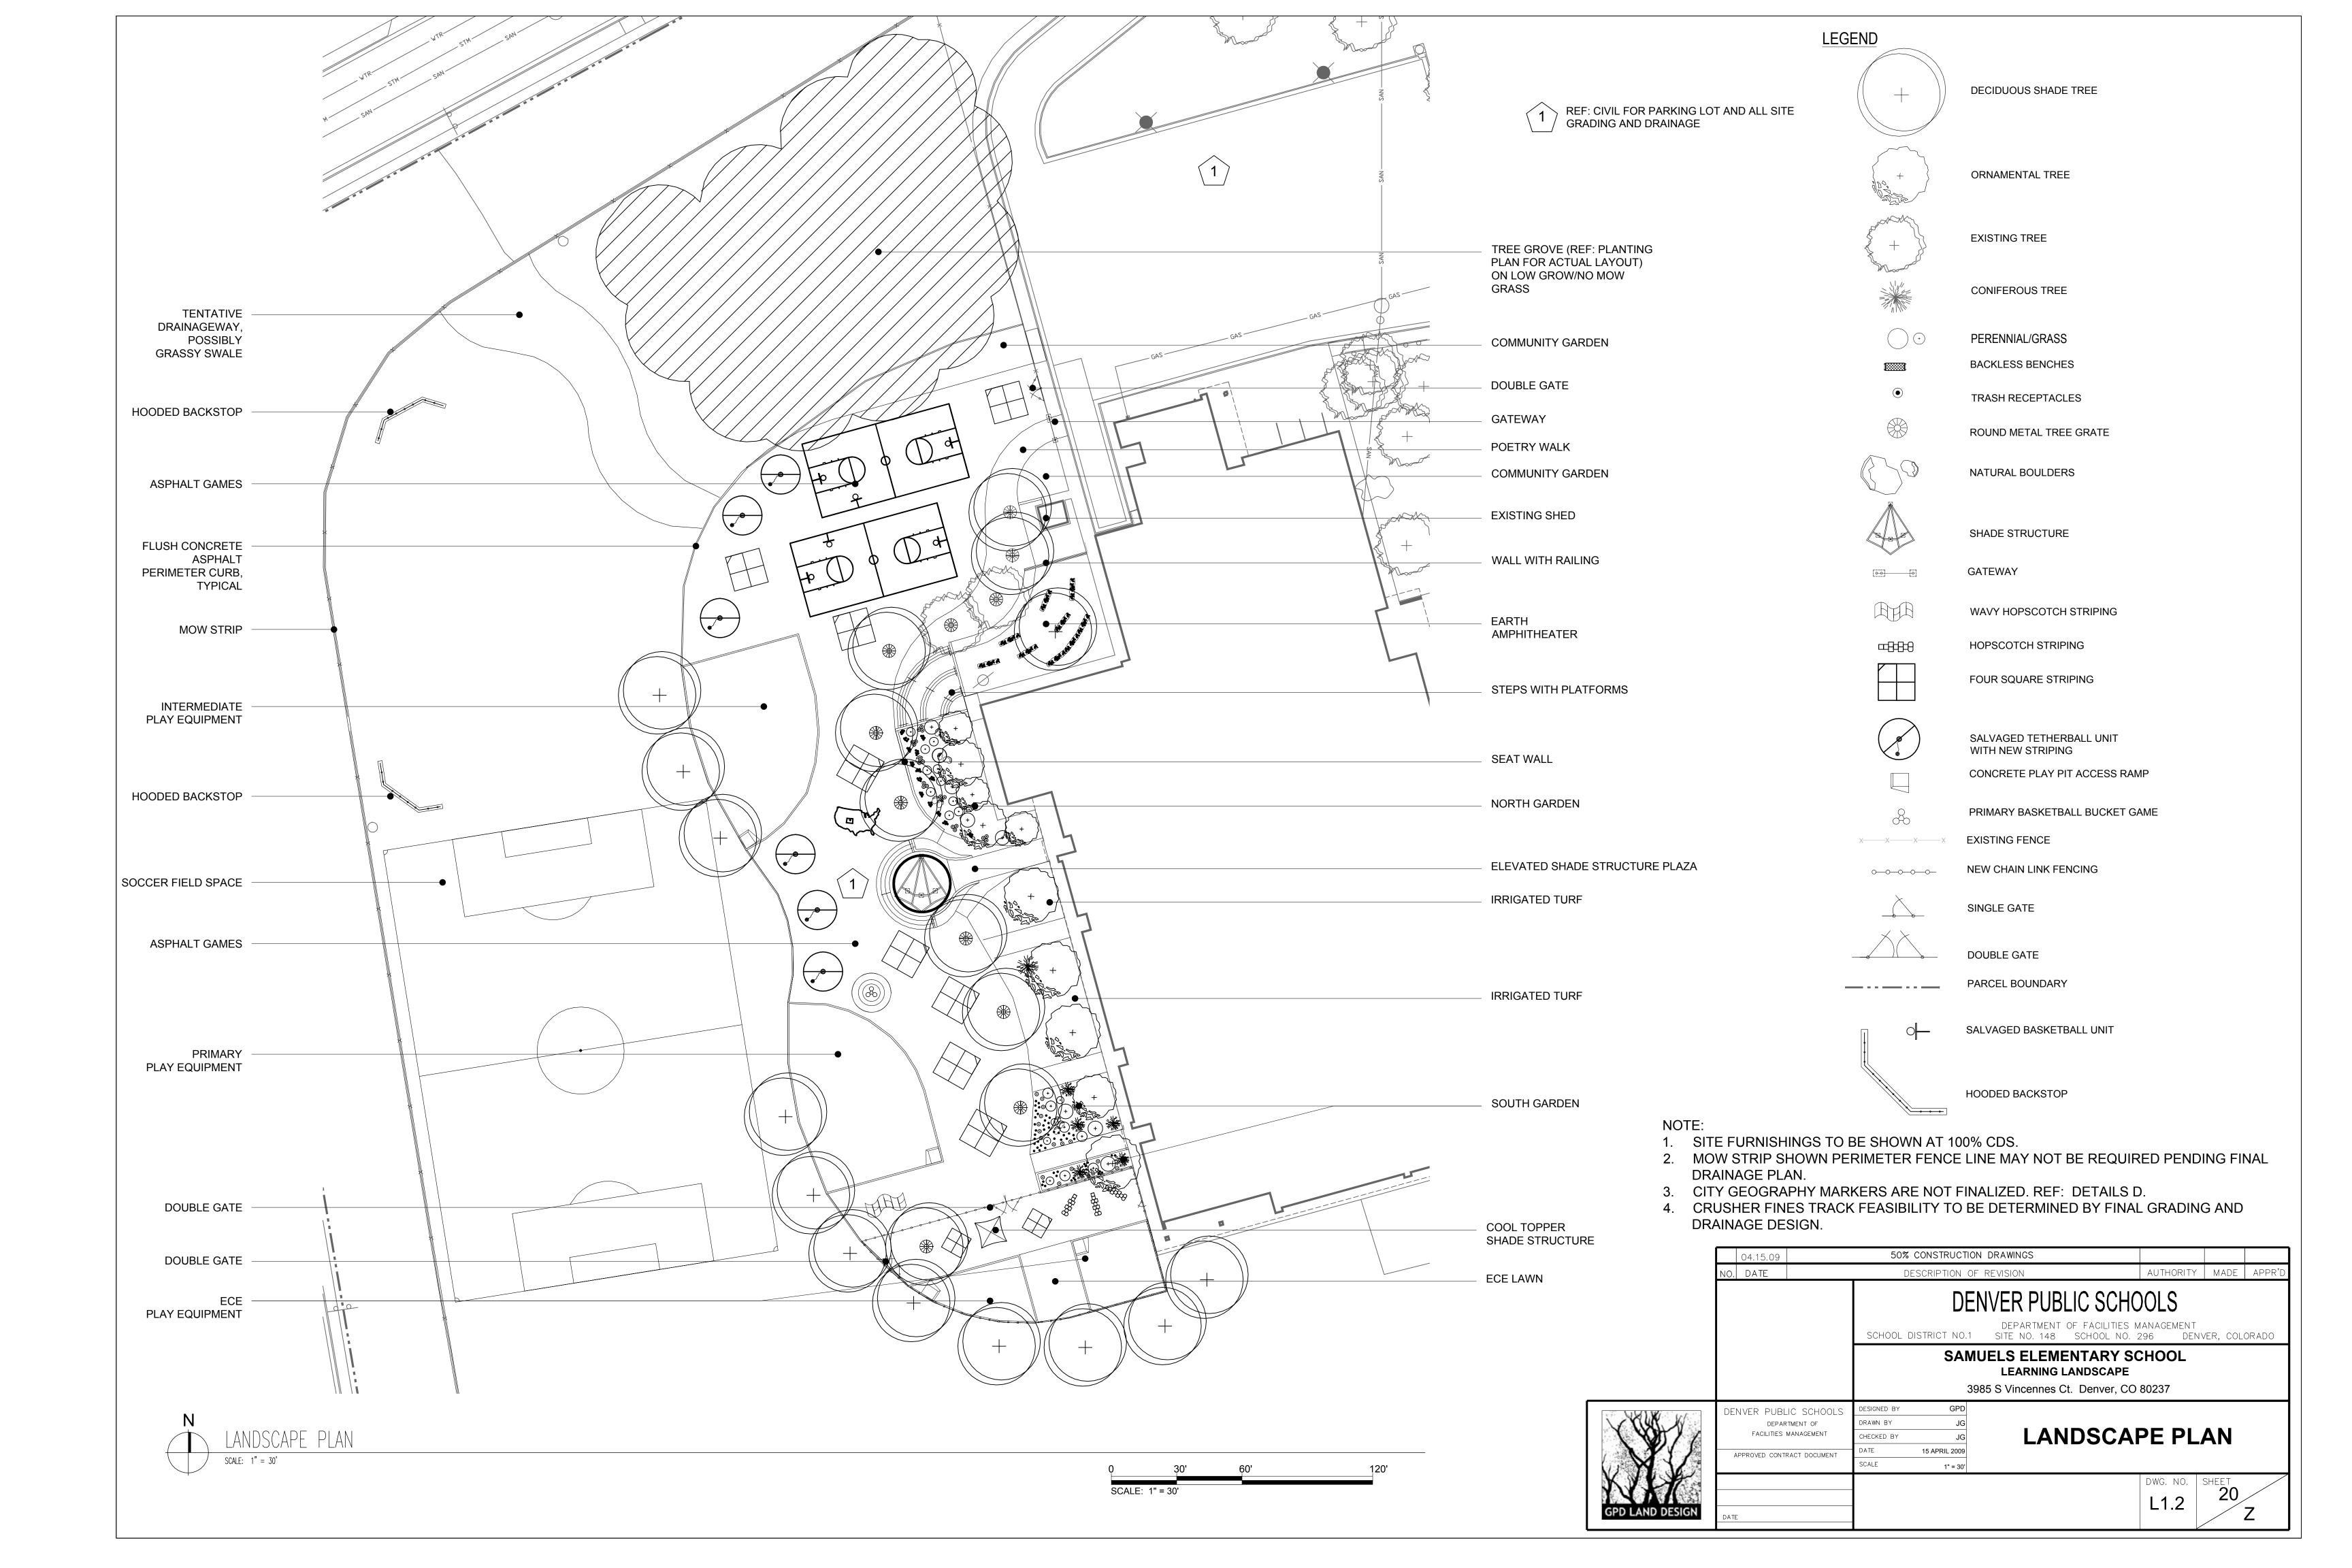




A 1671395.125 3129468.719 **B** 1671447.965 3129592.026 **C** 1671479.969 3129658.638 **D** 1671458.394 3129840.427 **E** 1671436.471 3129726.424 **F** 1671434.286 3129694.341 **G** 1671478.144 3129776.866 **H** 1671289.366 3129674.801 1671387.602 3129722.110 **J** 1671370.567 3129633.273 **K** 1671430.677 3129798.264 **L** 1671430.677 3129798.264 **M** 1671412.972 3129778.598 **N** 1671391.976 3129760.894 **O** 1671359.470 3129909.213 **P** 1671365.889 3129820.977 **Q** 1671364.801 3129775.304 **R** 1671374.747 3129833.566

NOTE: LAYOUT TO BE COMPLETED AT 100% CD SET.

NOTES

- 1. REF: PLANTING PLAN, SHEET___5 FOR LAYOUT OF TREES IN SOFT SURFACE.
- 2. COORDINATE BOULDER SELECTION, LOCATION, AND ORIENTATION WITH LANDSCAPE ARCHITECT FOR FIELD LAYOUT.
- 3. COORDINATE FINAL SITE FURNISHINGS LOCATIONS WITH LANDSCAPE ARCHITECT PRIOR TO INSTALLATION.
- 4. AUTOCAD LAYOUT FILE AVAILABLE TO THE CONTRACTOR PRIOR TO CONSTRUCTION IF DESIRED FOR FOR DIRECT INPUT OF INFORMATION BY SURVEYOR.
- 5. REF: CIVIL FOR PARKING LOT LAYOUT.
- 6. NORTHING & EASTINGS SHOW RELATIVE POSITIONS FROM FIXED SITE IMPROVEMENTS.
- 7. THE CONTRACTOR SHALL REPORT ANY DISCREPANCY IN PLAN VS. FIELD CONDITIONS IMMEDIATELY TO THE LANDSCAPE ARCHITECT, PRIOR TO CONTINUING WITH THAT PORTION OF WORK.
- 8. GENERAL: ENDS OF STRAIGHT SECTIONS AND BEGINNINGS OF RADII ARE INDICATED ON THIS PLAN BY CIRCLES.
- 9. TANGENT POINTS OF CURVES TO HAVE SMOOTH TRANSITION TO LINES OR
- CURVES OF ANOTHER RADIUS. 10. ALL PLAY PIT DIMENSIONING FROM PIT INTERIOR AS SHOWN. ALL INTERIOR PIT
- MEASUREMENTS TO REMAIN AS DRAWN. PLAY PIT AND PLAY PIT RAMP DIMENSIONS AND PLACEMENT MUST NOT VARY FROM PLAN. RAMPS SLOPE @
- 11. THE CONTRACTOR IS RESPONSIBLE FOR THE COST TO REPAIR UTILITIES, LANDSCAPE ELEMENTS, PUBLIC AND/OR PRIVATE PROPERTY THAT IS DAMAGED BY THE CONTRACTOR OR THEIR SUBCONTRACTOR'S OPERATIONS DURING INSTALLATION OR DURING THE SPECIFIED MAINTENANCE PERIOD.
- 12. THE CONTRACTOR SHALL BE RESPONSIBLE FOR THE REPAIR OF ANY OF THEIR TRENCHES OR EXCAVATIONS THAT SETTLE.
- 13. CONTRACTOR TO COORDINATE LOCATION OF IRRIGATION SLEEVES AND ELECTRICAL CONDUIT PRIOR TO CONSTRUCTION.
- 14. PROVIDE RECESSED AND CAULKED EXPANSION JOINTS AS SHOWN AND PER WRITTEN SPECIFICATIONS WHERE CONCRETE FLATWORK MEETS VERTICAL STRUCTURES SUCH AS WALLS, RAMPS, CURBS, STEPS, AND BUILDING ELEMENTS.
- 15. CONTROL JOINTS TO BE AS SHOWN.
- 16. PLANTS AND IRRIGATION ADJACENT TO BUILDING TO BE MINIMUM 2' FROM EDGE OF BUILDING.

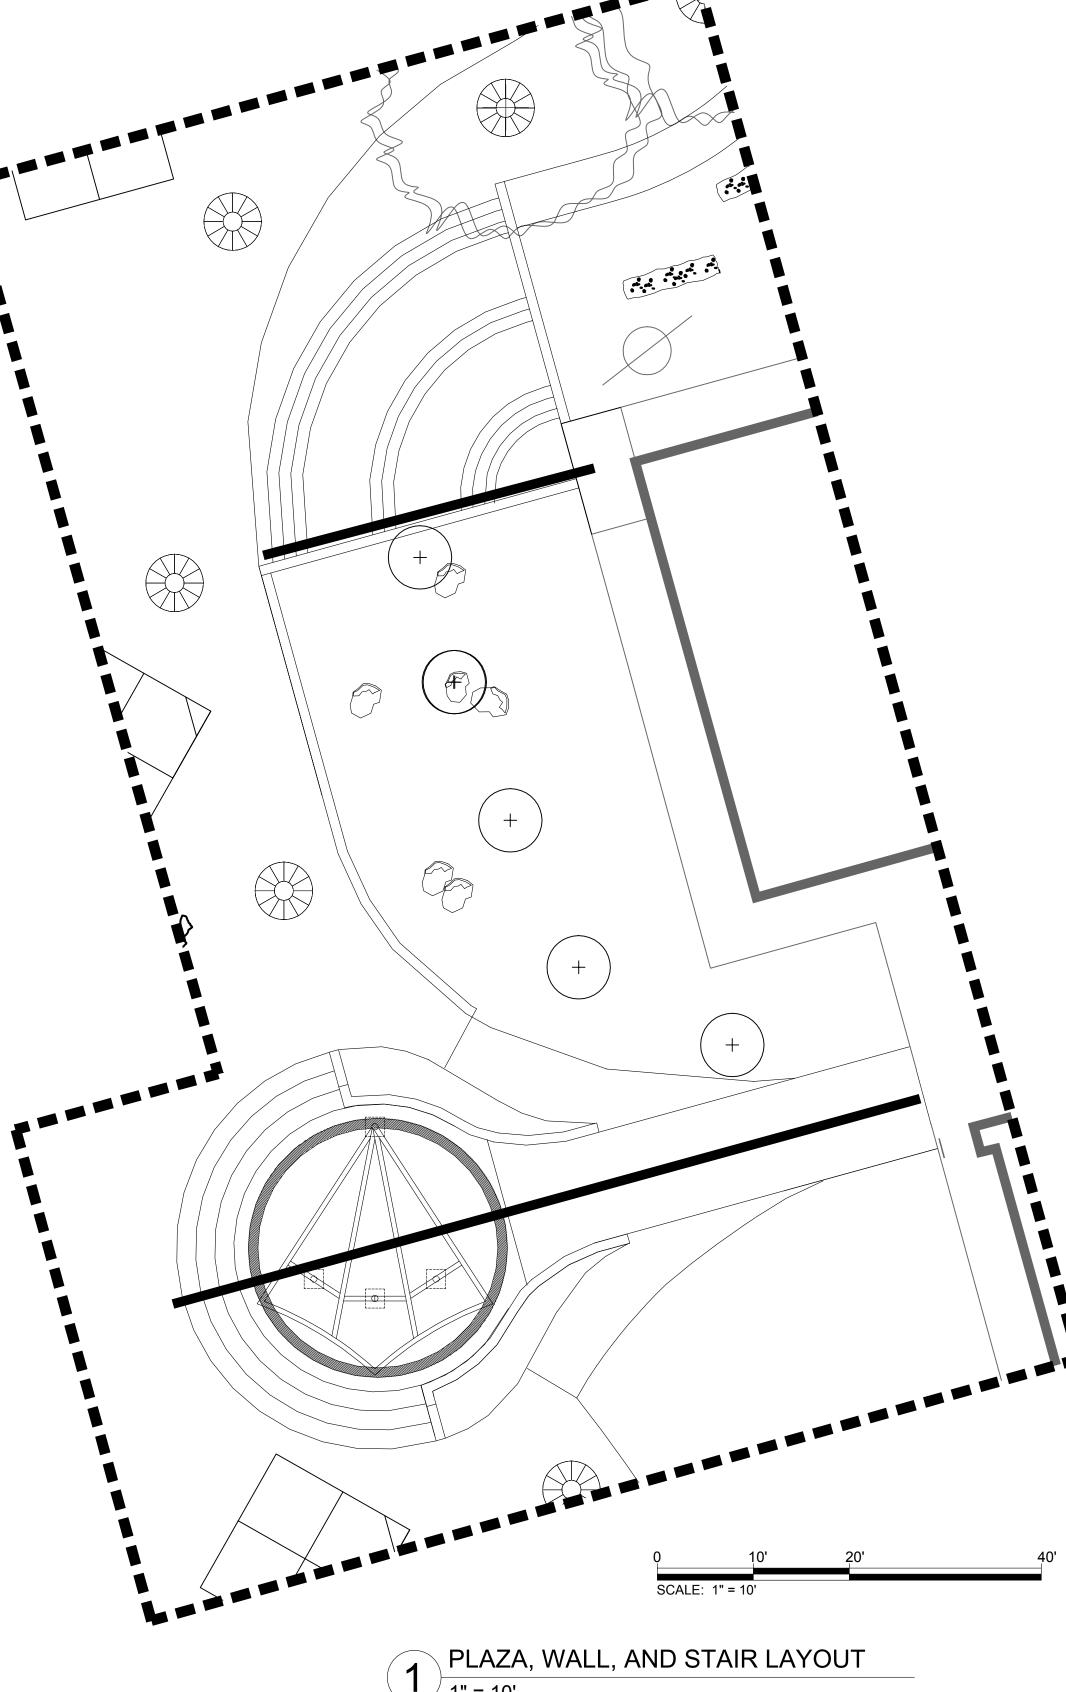


1 PLAZA, WALL, AND STAIR LAYOUT


1" = 10'


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						JELS ELEME LEARNING I 35 S Vincennes C	LANDSCAPE			
		DEPAF FACILITIES	LIC SCHOOLS RIMENT OF MANAGEMENT RACT DOCUMENT	DESIGNED BY DRAWN BY CHECKED BY DATE SCALE	GPD JG JG 15 APRIL 2009 VARIES	L	AYOUT	PLA	N	
GPD LAND DESIGN	DATE	-			,			DWG. NO.	SHEET 20	7

NOTES:

- THE WORK INCLUDES ALL SOD, PLANTINGS AND IRRIGATION AS SHOWN AND AS DISTURBED BY THE WORK.
- TURF AREAS SHOWN ON THIS SHEET ARE COMPLETE AREAS OF SOD KNOWN TO REQUIRE REPLACEMENT DUE TO REGRADING OR NEW SITE WORK. IN ADDITION, CONTRACTOR TO PATCH BACK AREAS OF IRRIGATION TRENCH LINES, VALVES, RELOCATED HEADS, ETC. IN ALL AREAS OF NEW IRRIGATION. REF: IRRIGATION PLANS AND DETAILS.
- 3. THE CONTRACTOR SHALL REPORT ANY DISCREPANCY IN PLAN VS. FIELD CONDITIONS IMMEDIATELY TO THE LANDSCAPE ARCHITECT, PRIOR TO CONTINUING WITH THAT PORTION OF WORK.
- 4. THE CONTRACTOR SHALL NOT DISTURB THE EXISTING PAVING, LIGHTING, LANDSCAPING OR IRRIGATION THAT EXISTS ADJACENT TO THE SITE UNLESS EXCEPT AS SHOWN ON THE DRAWINGS. REF: CIVIL AND IRRIGATION DEMOLITION PLANS.
- 5. THE CONTRACTOR IS RESPONSIBLE FOR THE COST TO REPAIR UTILITIES, ADJACENT LANDSCAPE, PUBLIC AND/OR PRIVATE PROPERTY THAT IS DAMAGED BY THE CONTRACTOR OR THEIR SUBCONTRACTOR'S OPERATIONS DURING INSTALLATION OR DURING THE SPECIFIED MAINTENANCE PERIOD. CALL FOR UTILITY LOCATES PRIOR TO ANY EXCAVATION.
- ALL PLANTING AREAS ARE TO BE AMENDED AND TILLED PER THE WRITTEN SPECIFICATIONS.
- THE CONTRACTOR SHALL FURNISH AND INSTALL PLANT MATERIAL AS NOTED. SHOULD A DISCREPANCY IN QUANTITIES OCCUR, THE PLANT QUANTITIES ON THE PLAN SHALL TAKE PRECEDENCE OVER THOSE IN THE PLANT SCHEDULE. LIKE SIZES AND FORMS SHALL BE CHOSEN WITHIN EACH SPECIES.
- 8. ALL LANDSCAPE MATERIAL TO BE DISEASE AND INSECT FREE. ALL PLANT MATERIAL IS SUBJECT TO THE APPROVAL OF THE LANDSCAPE ARCHITECT
- NOTE: OWNER AND LANDSCAPE ARCHITECT TO INSPECT ALL IRRIGATION TRENCHES PRIOR TO BACKFILL. ADDITIONAL INSPECTIONS ARE INCLUDED IN WRITTEN SPECIFICATIONS, DIVISION 2, SECTION 02810.
- THE CONTRACTOR SHALL BE RESPONSIBLE FOR THE REPAIR TO ANY TRENCHES OR EXCAVATION THAT SETTLE.
- 11. PLANTS AND IRRIGATION ADJACENT TO BUILDING TO BE MINIMUM 2' FROM EDGE OF BUILDING.
- DETAILS OCCURRING MULTIPLE TIMES MAY ONLY BE CALLED OUT ONCE. SEE SHEET ____ FOR PLANTING DETAILS.
- 13. GARDEN AREAS TO HAVE PINNED LANDSCAPE FABRIC AND CEDAR MULCH. SEE LANDSCAPE DETAILS __ AND ___, SHEET___.

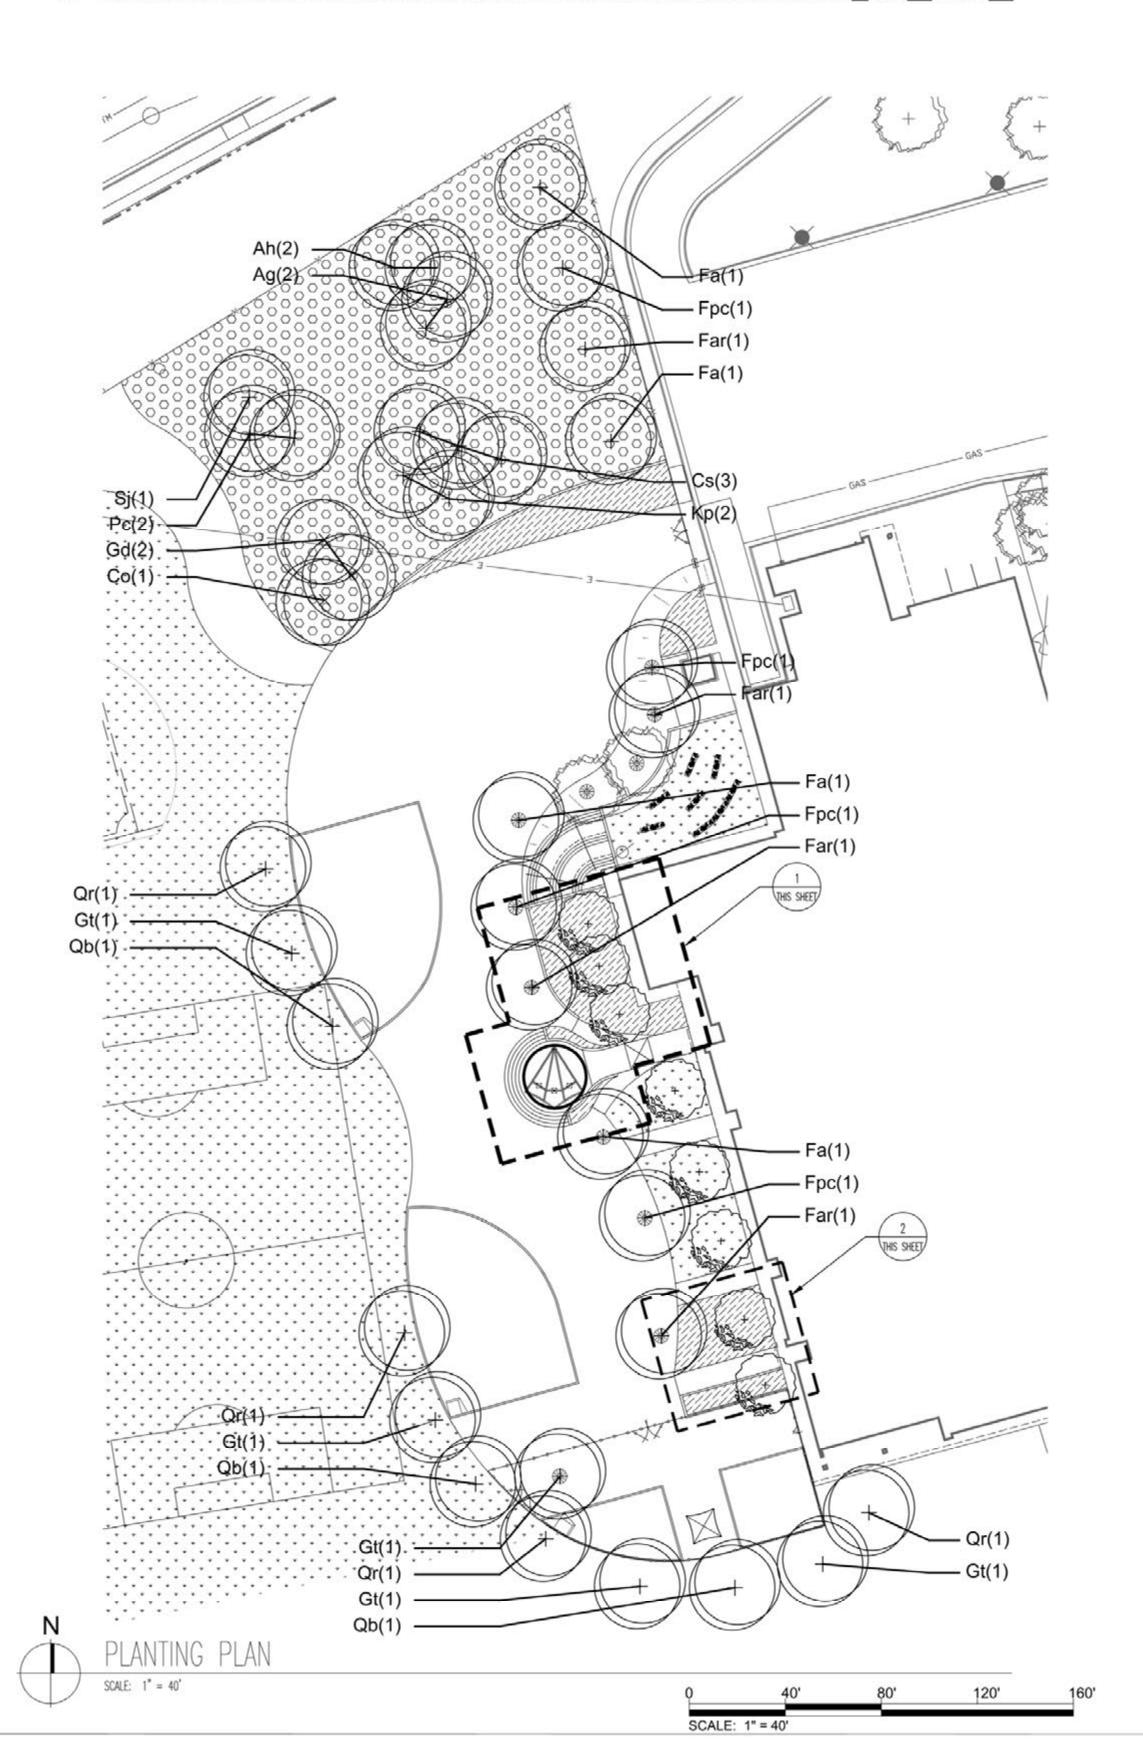

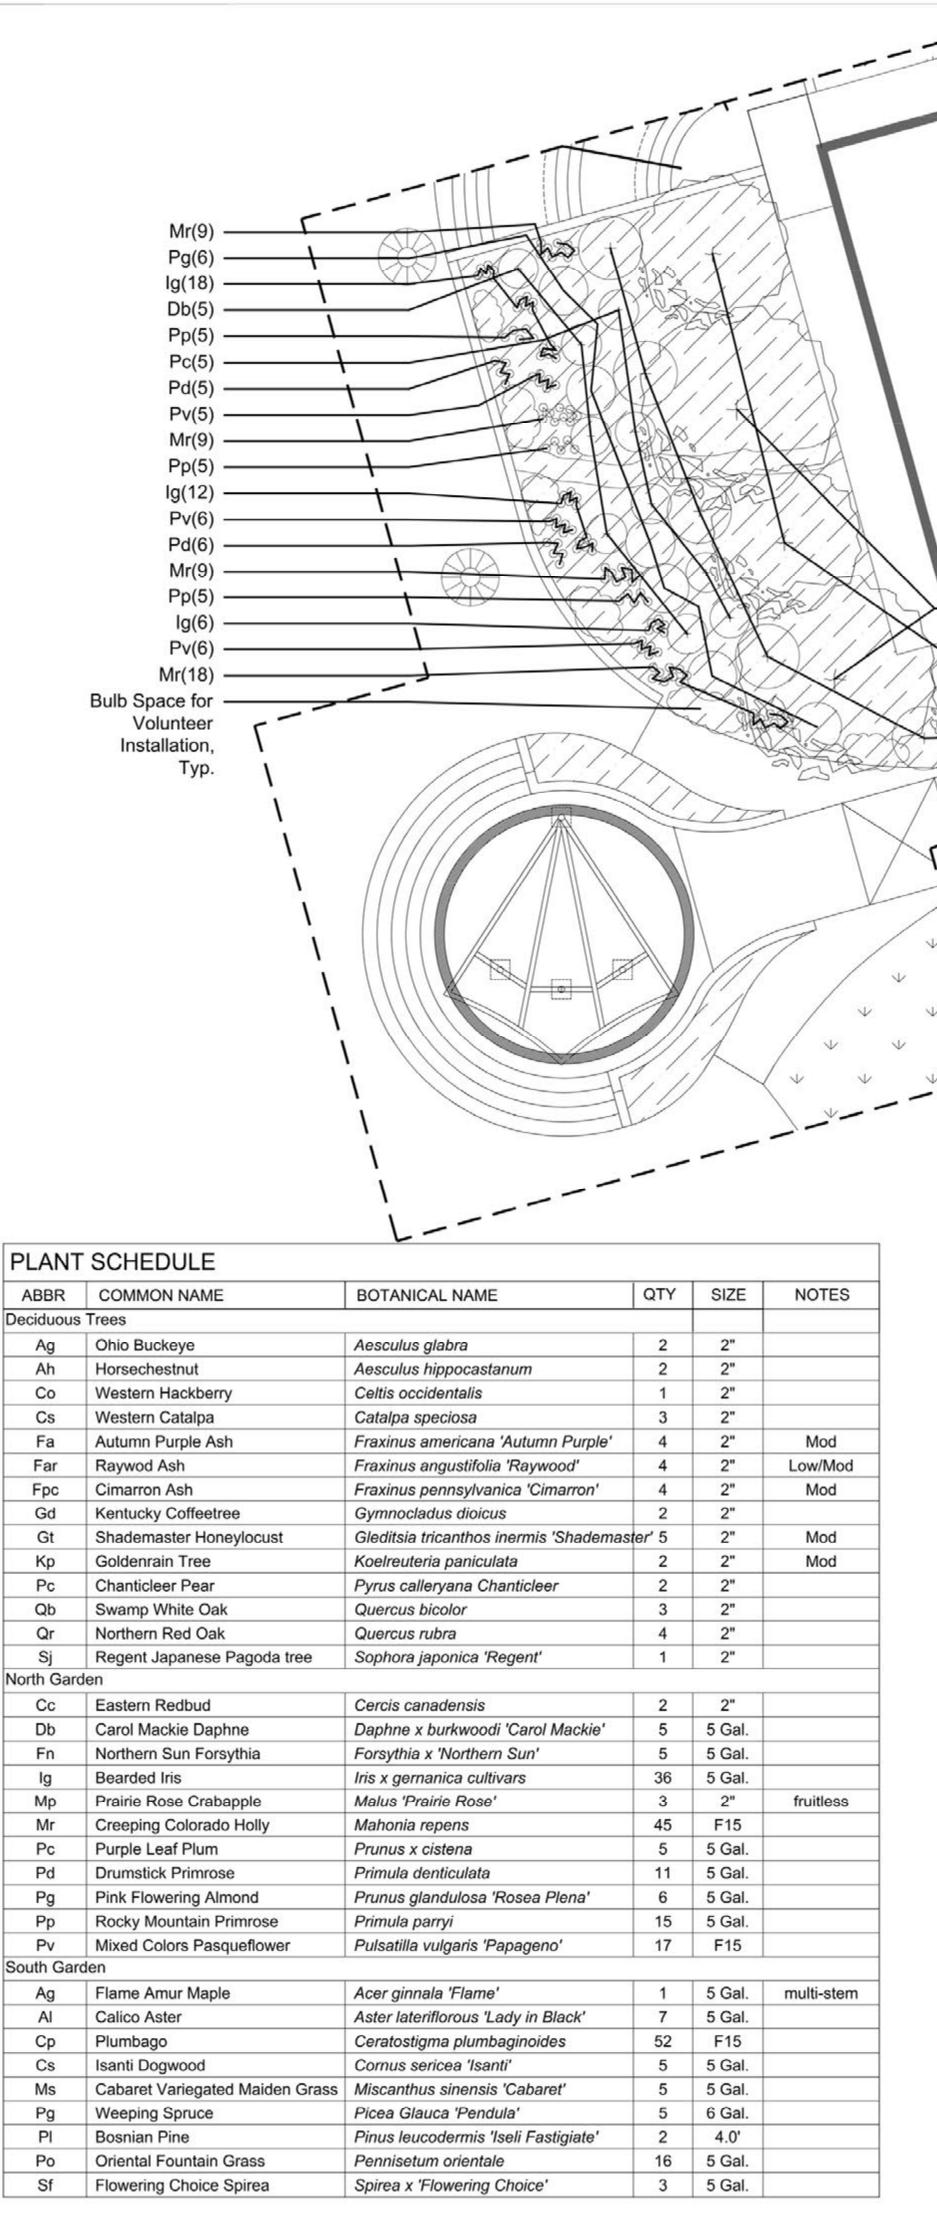

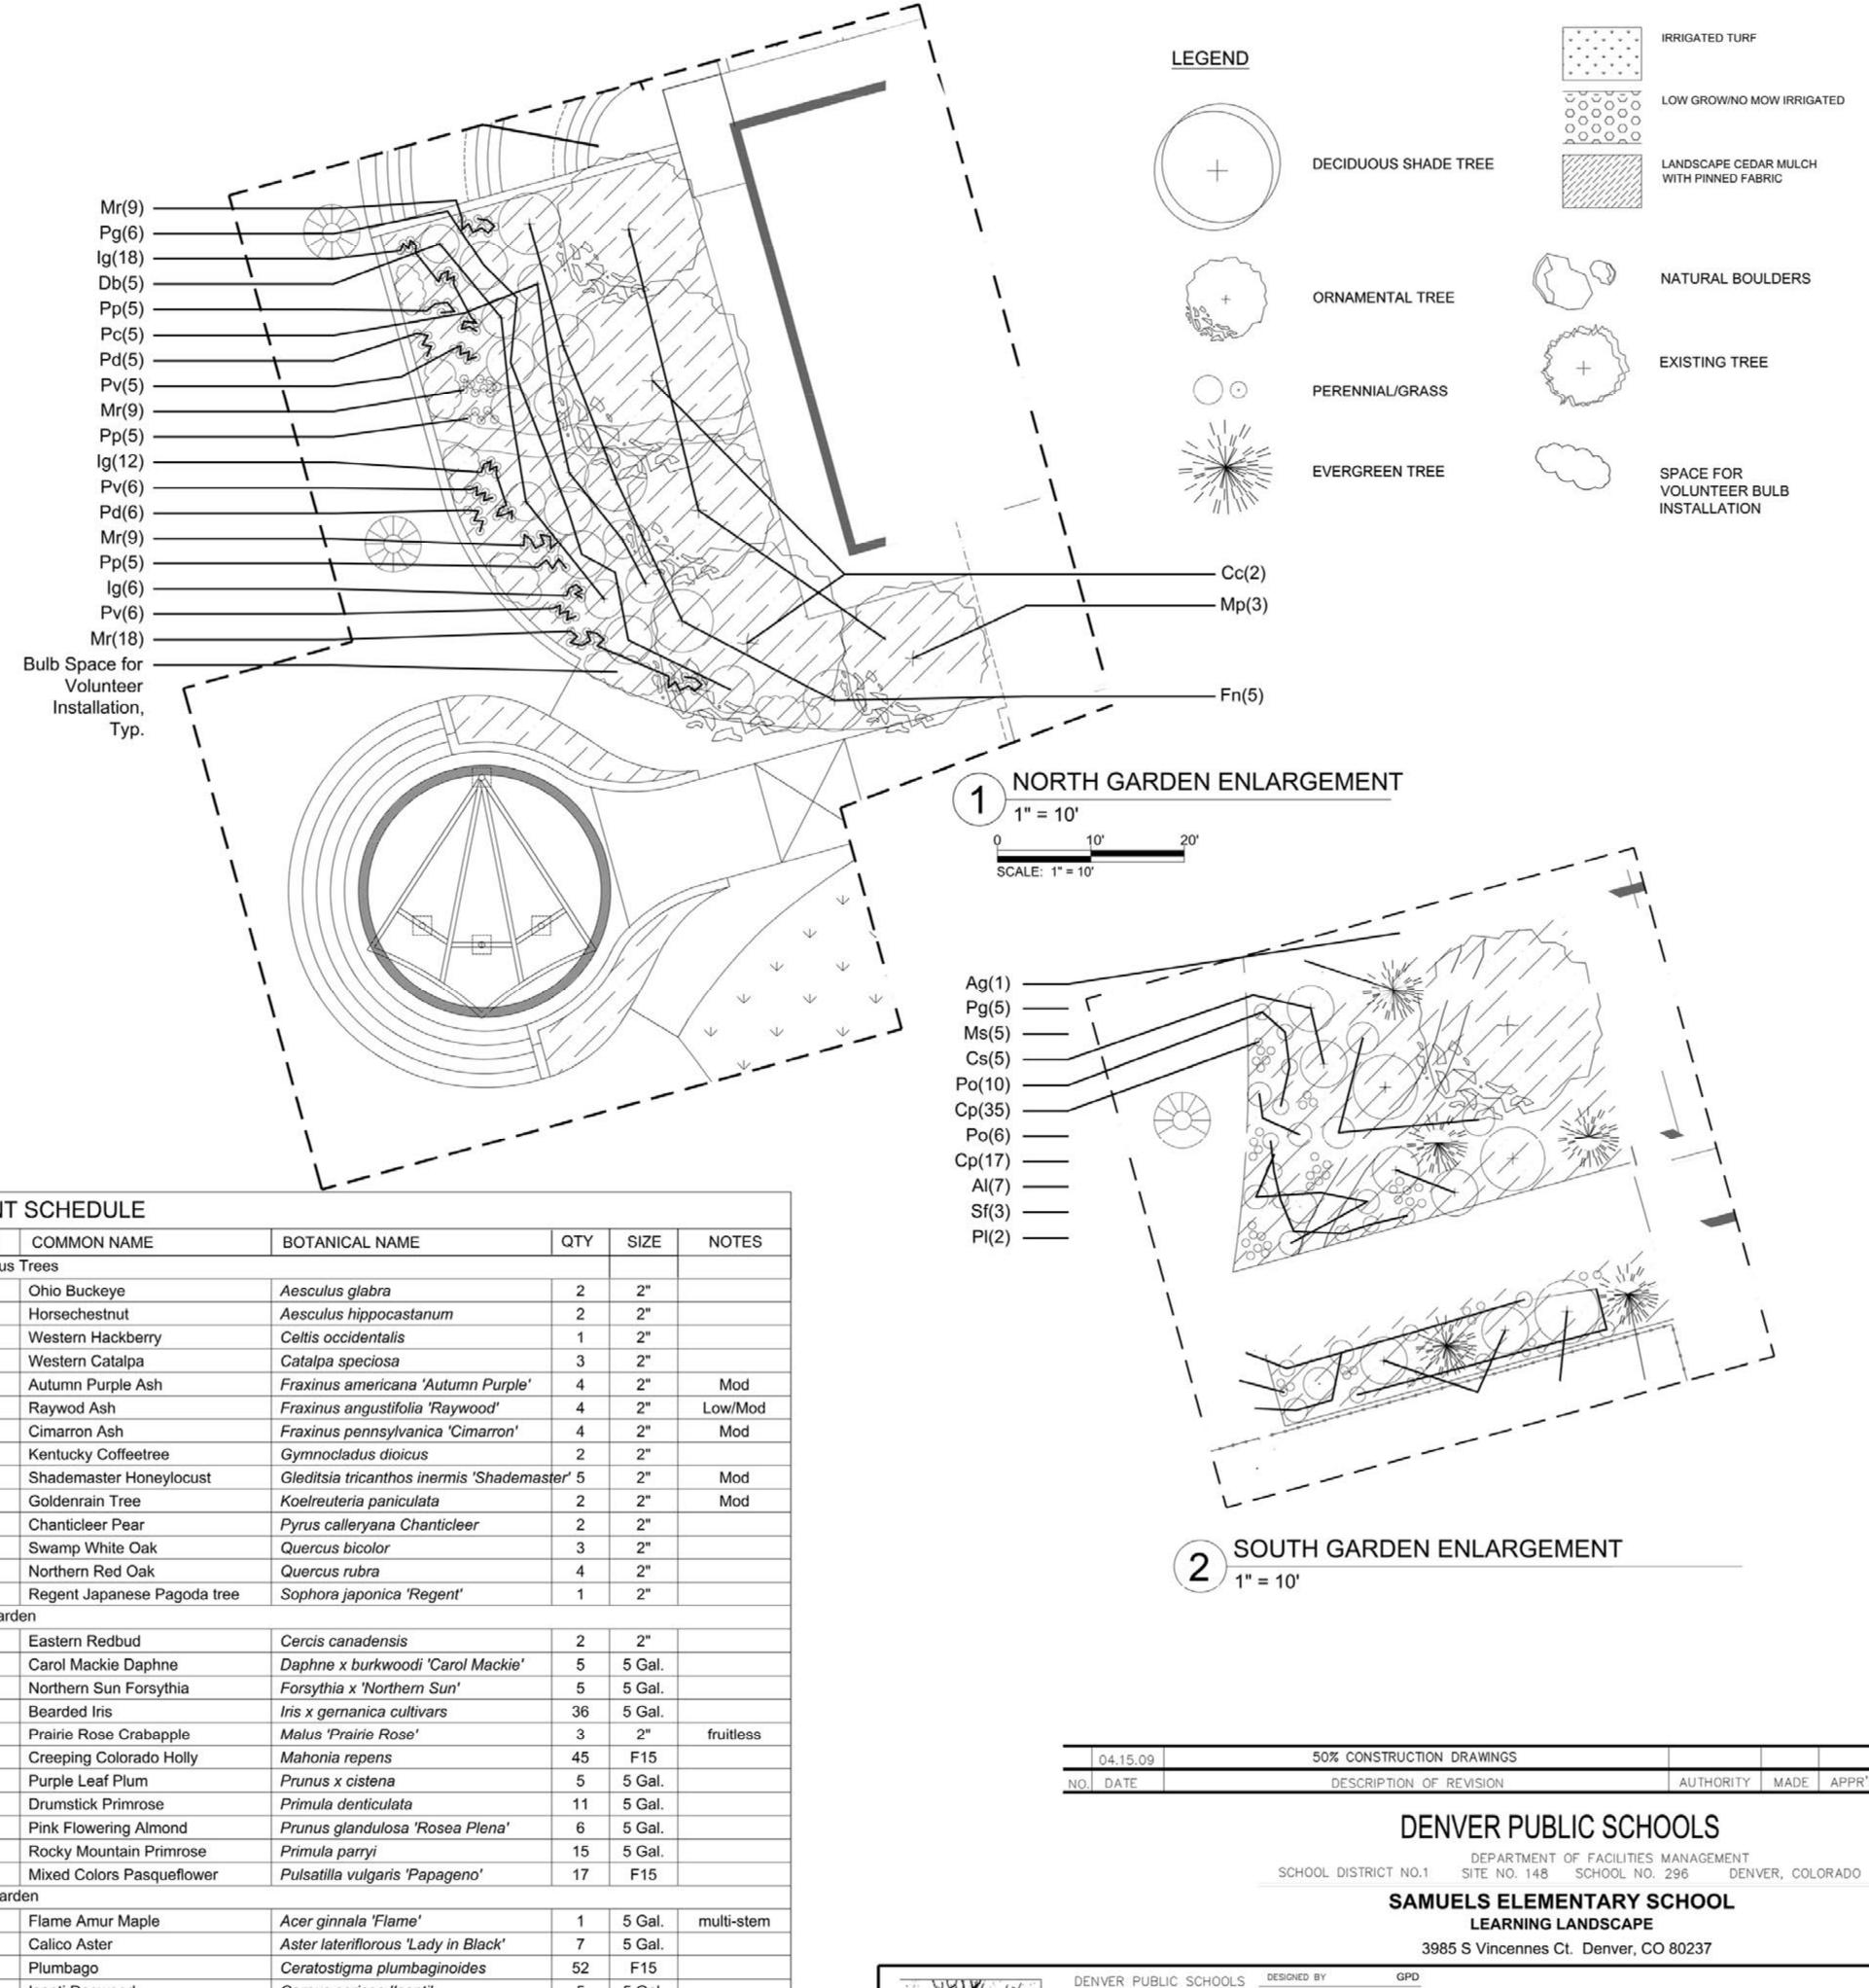

DEPARTMENT OF

CHECKED BY


15 APRIL 2009


FACILITIES MANAGEMENT


APPROVED CONTRACT DOCUMENT


PLANTING PLAN

L1.5

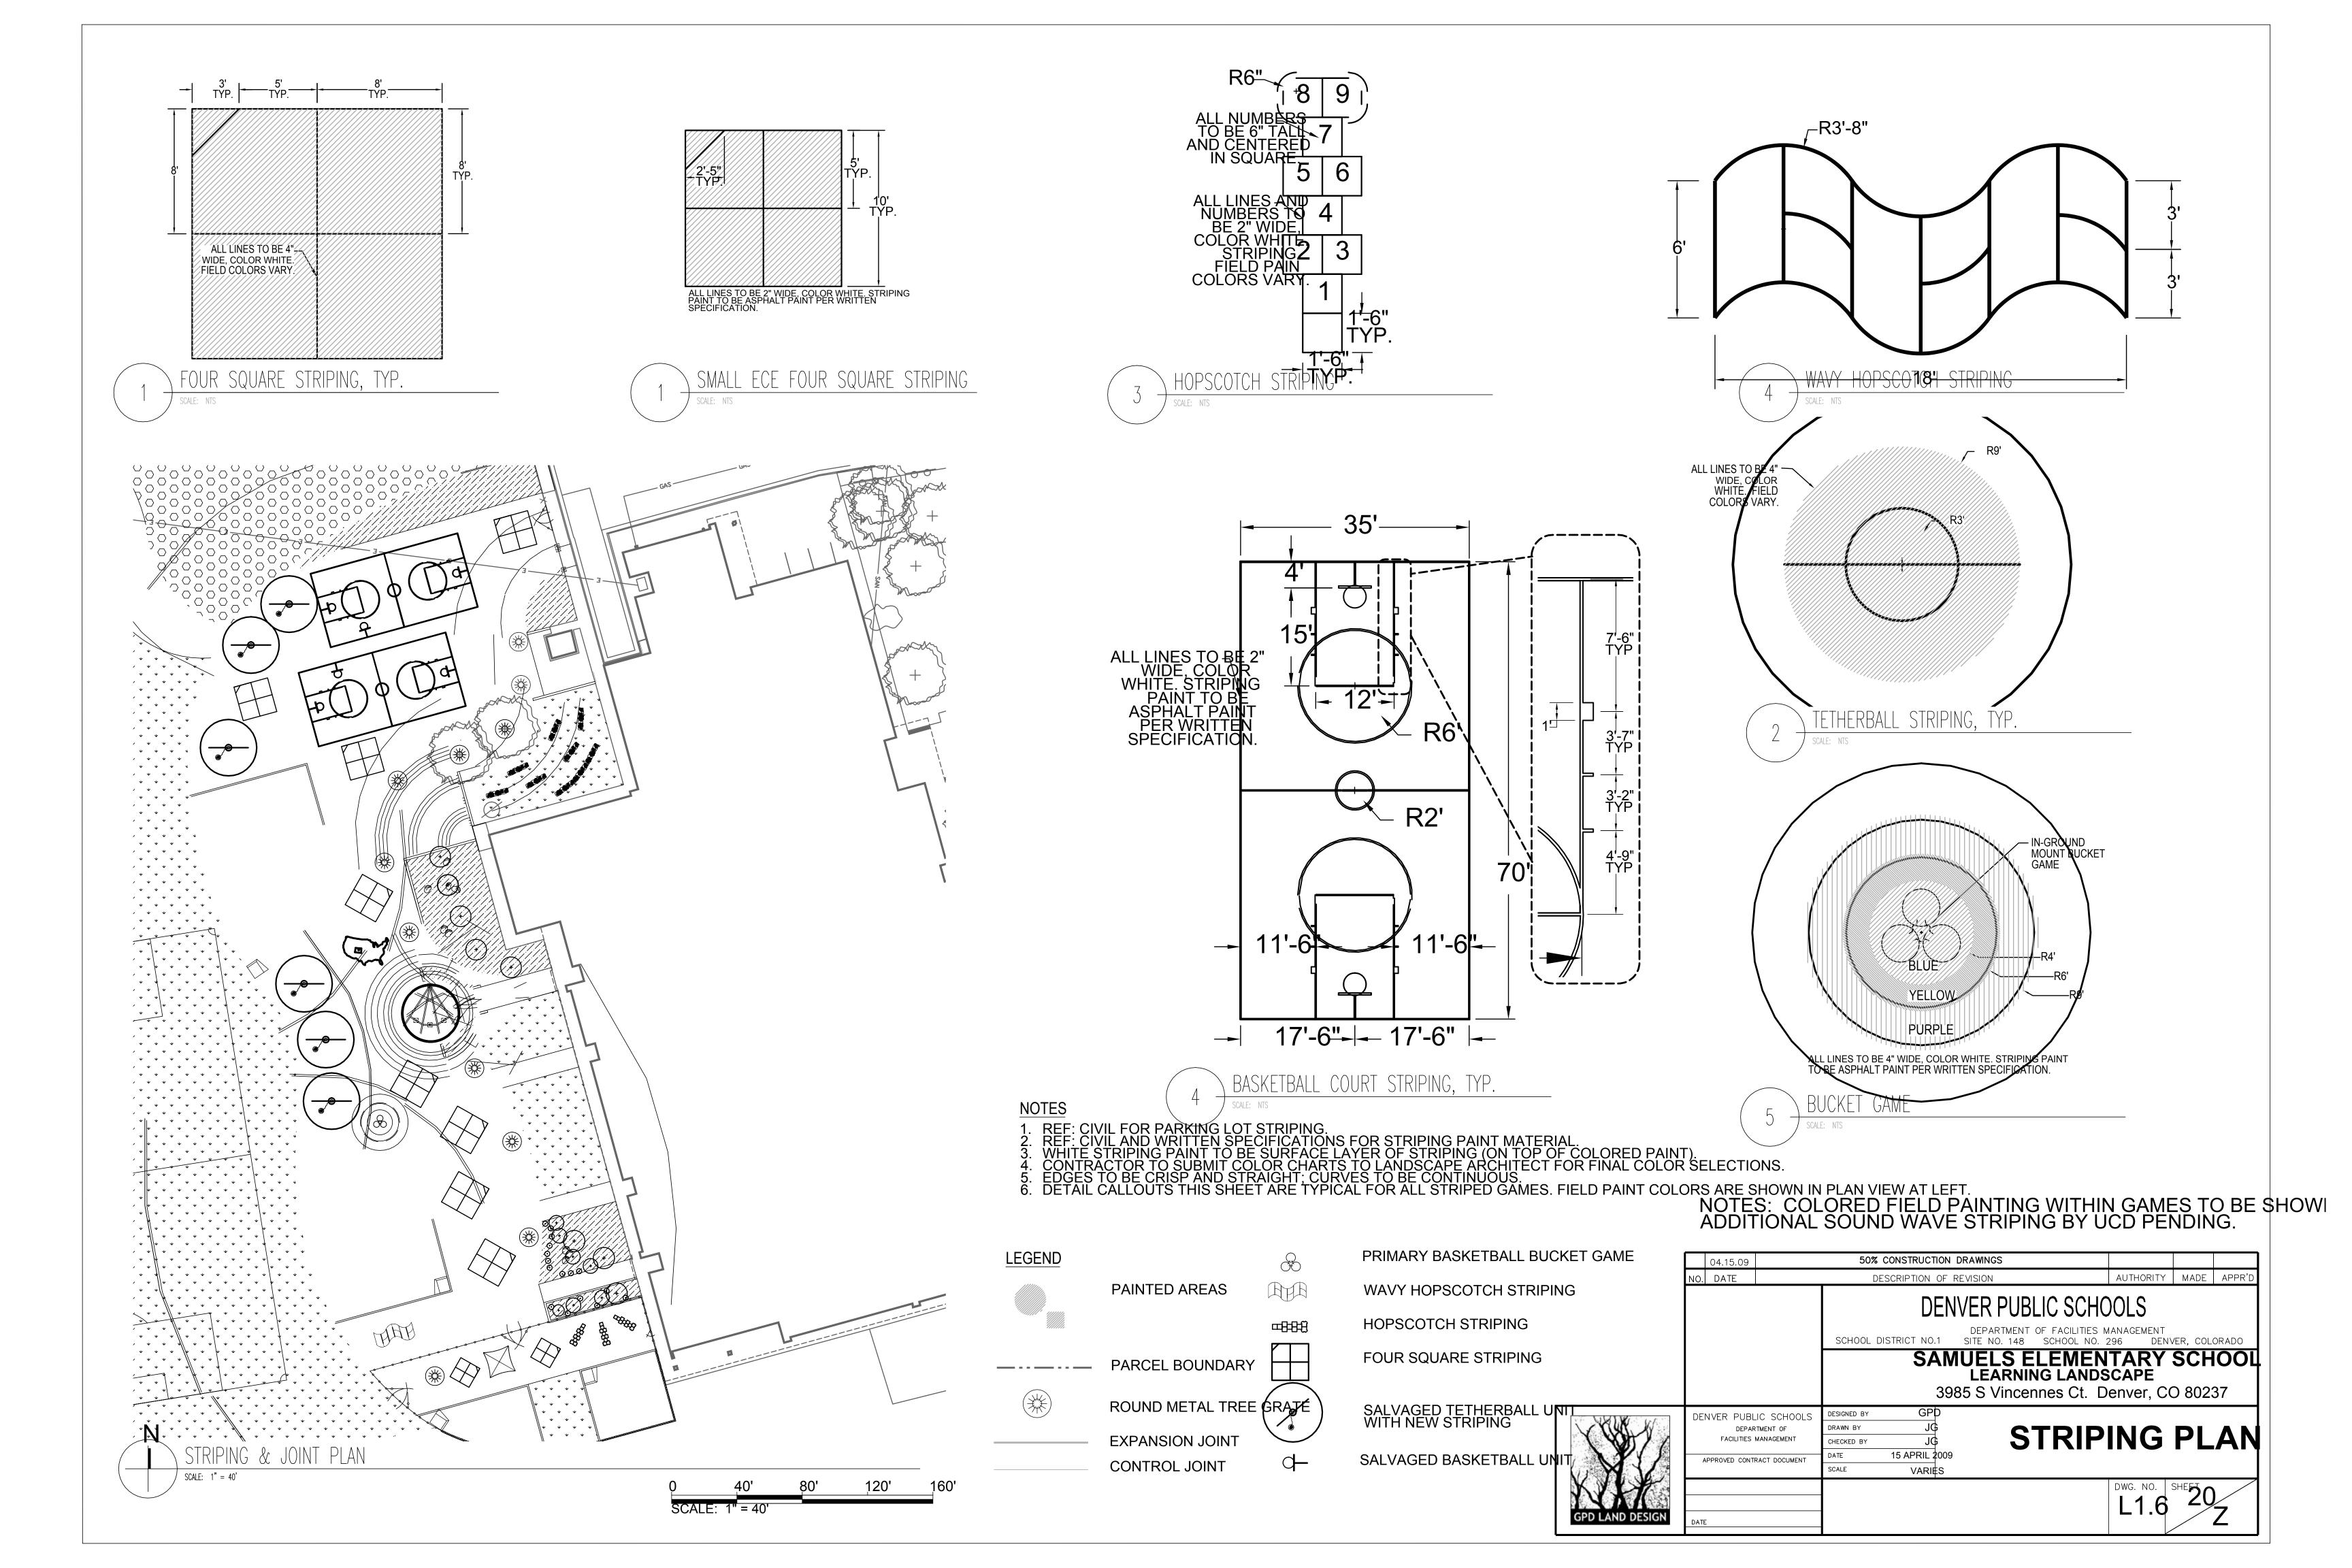

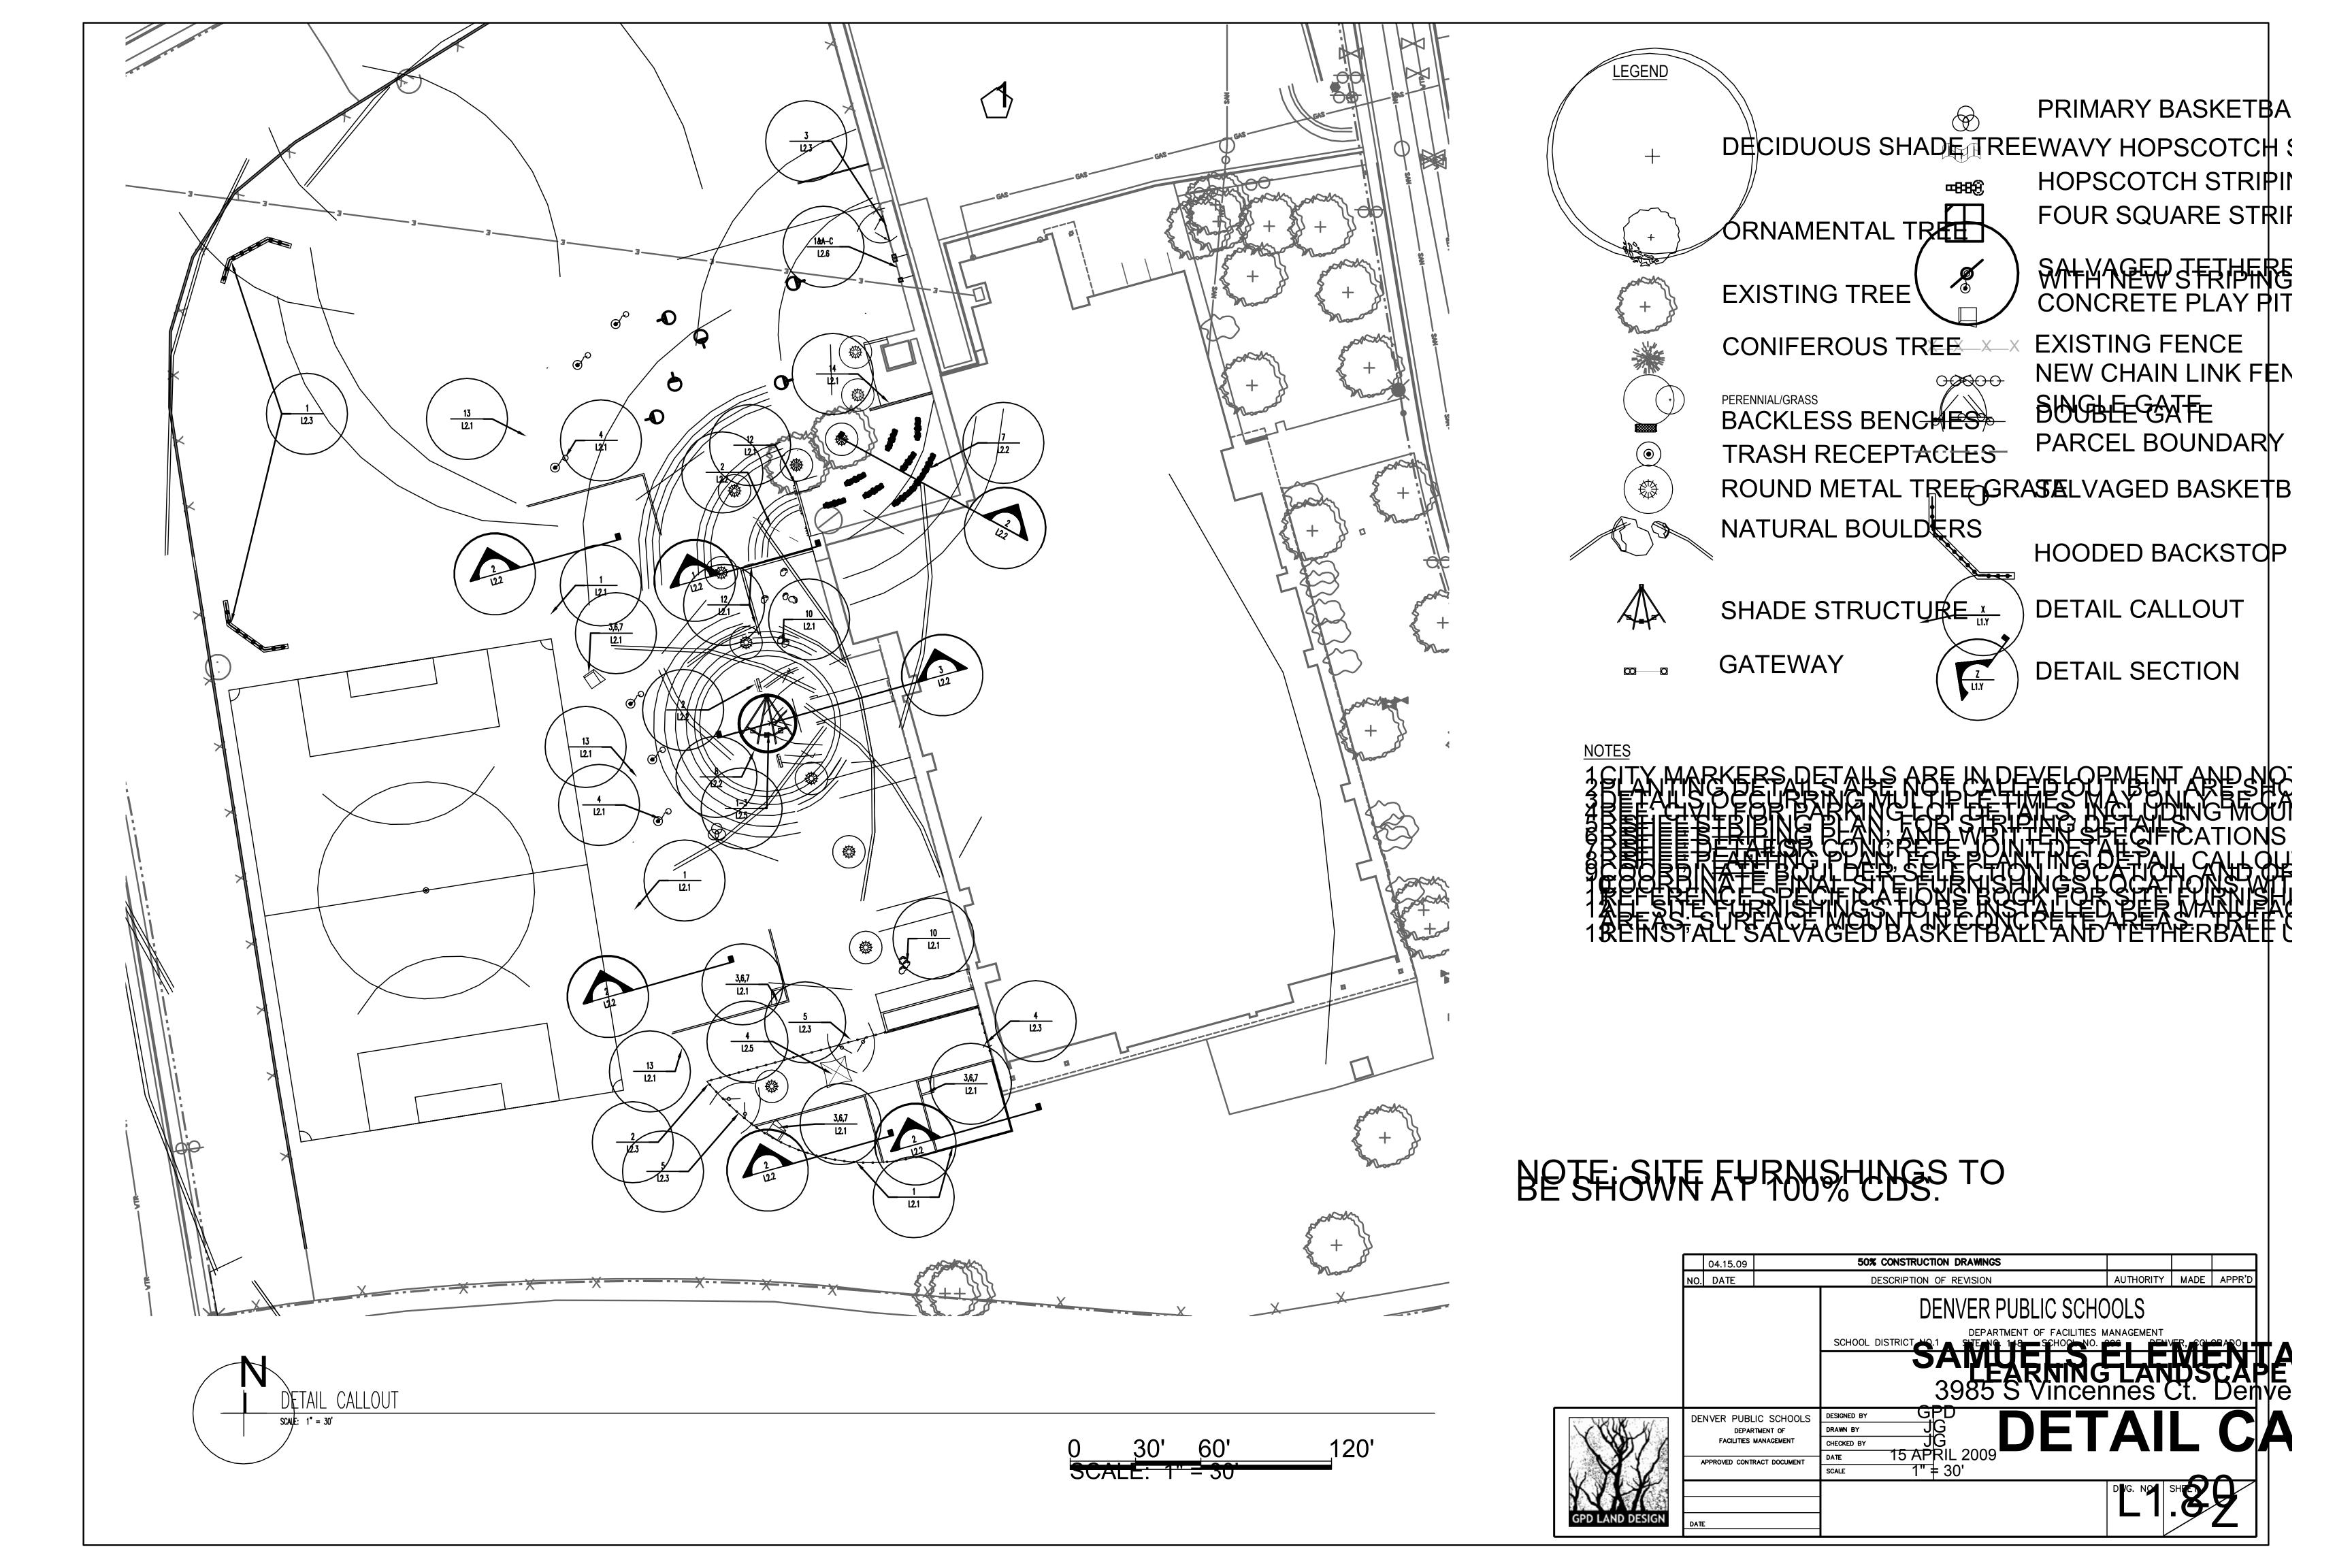

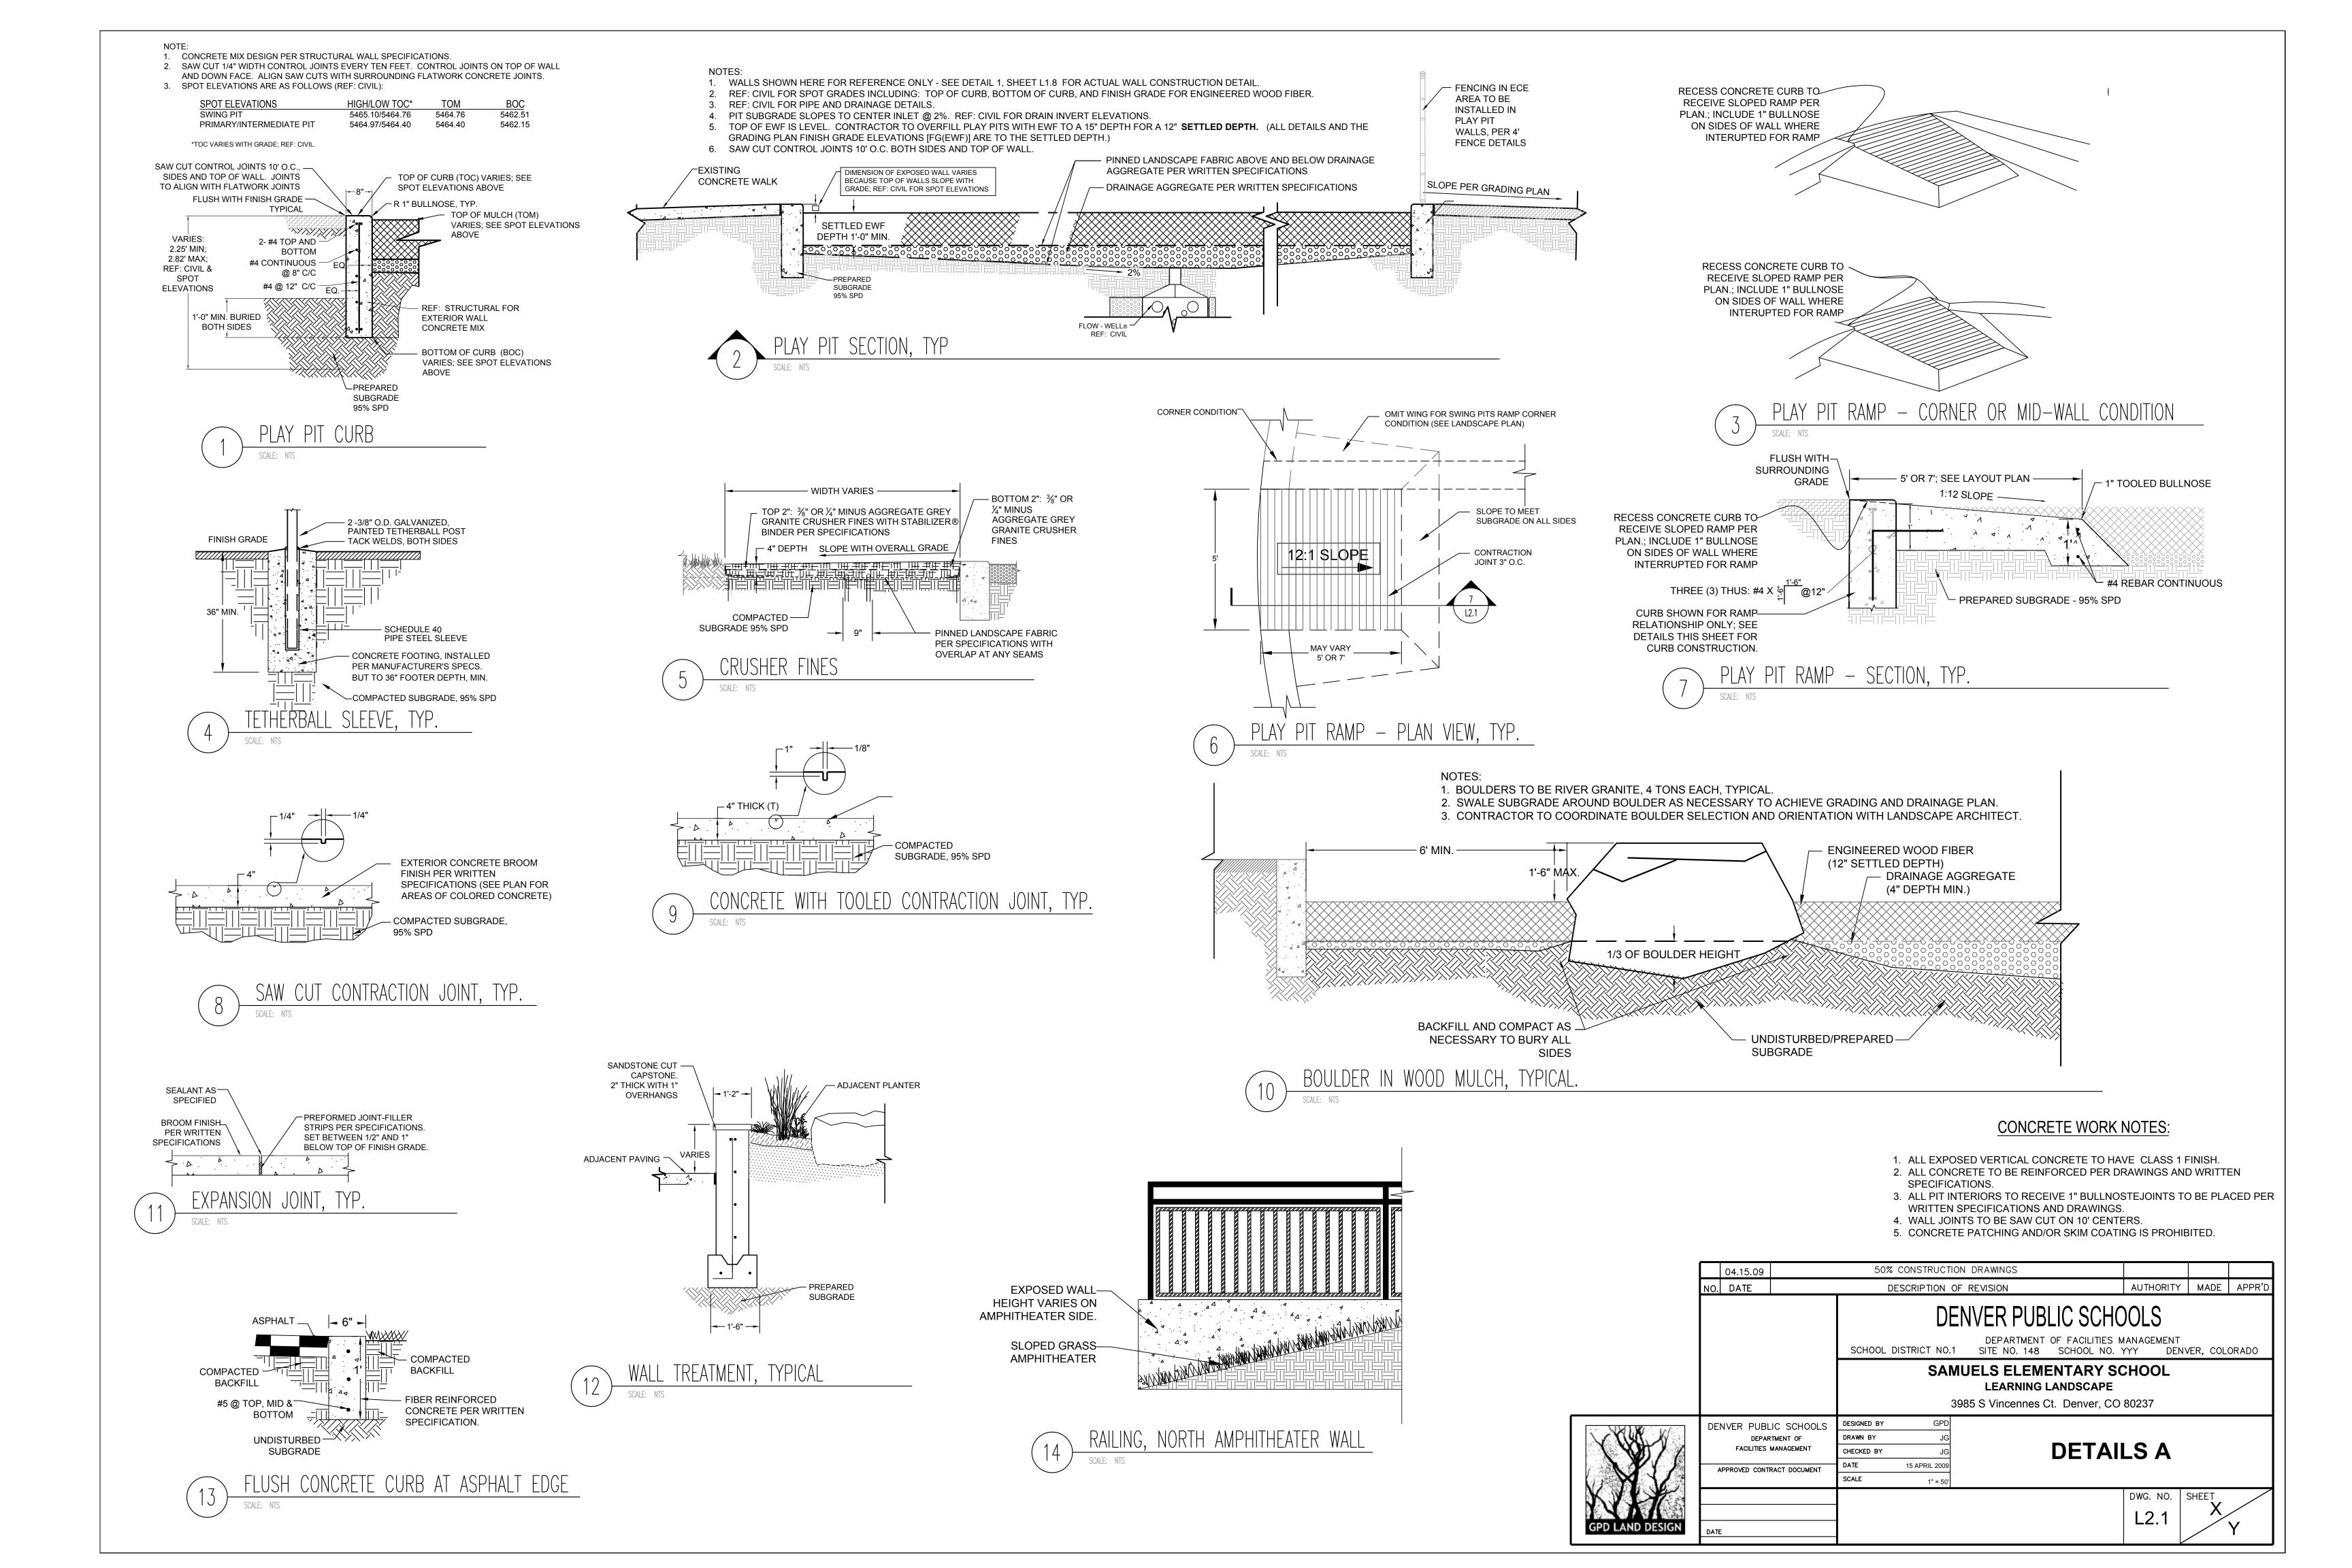

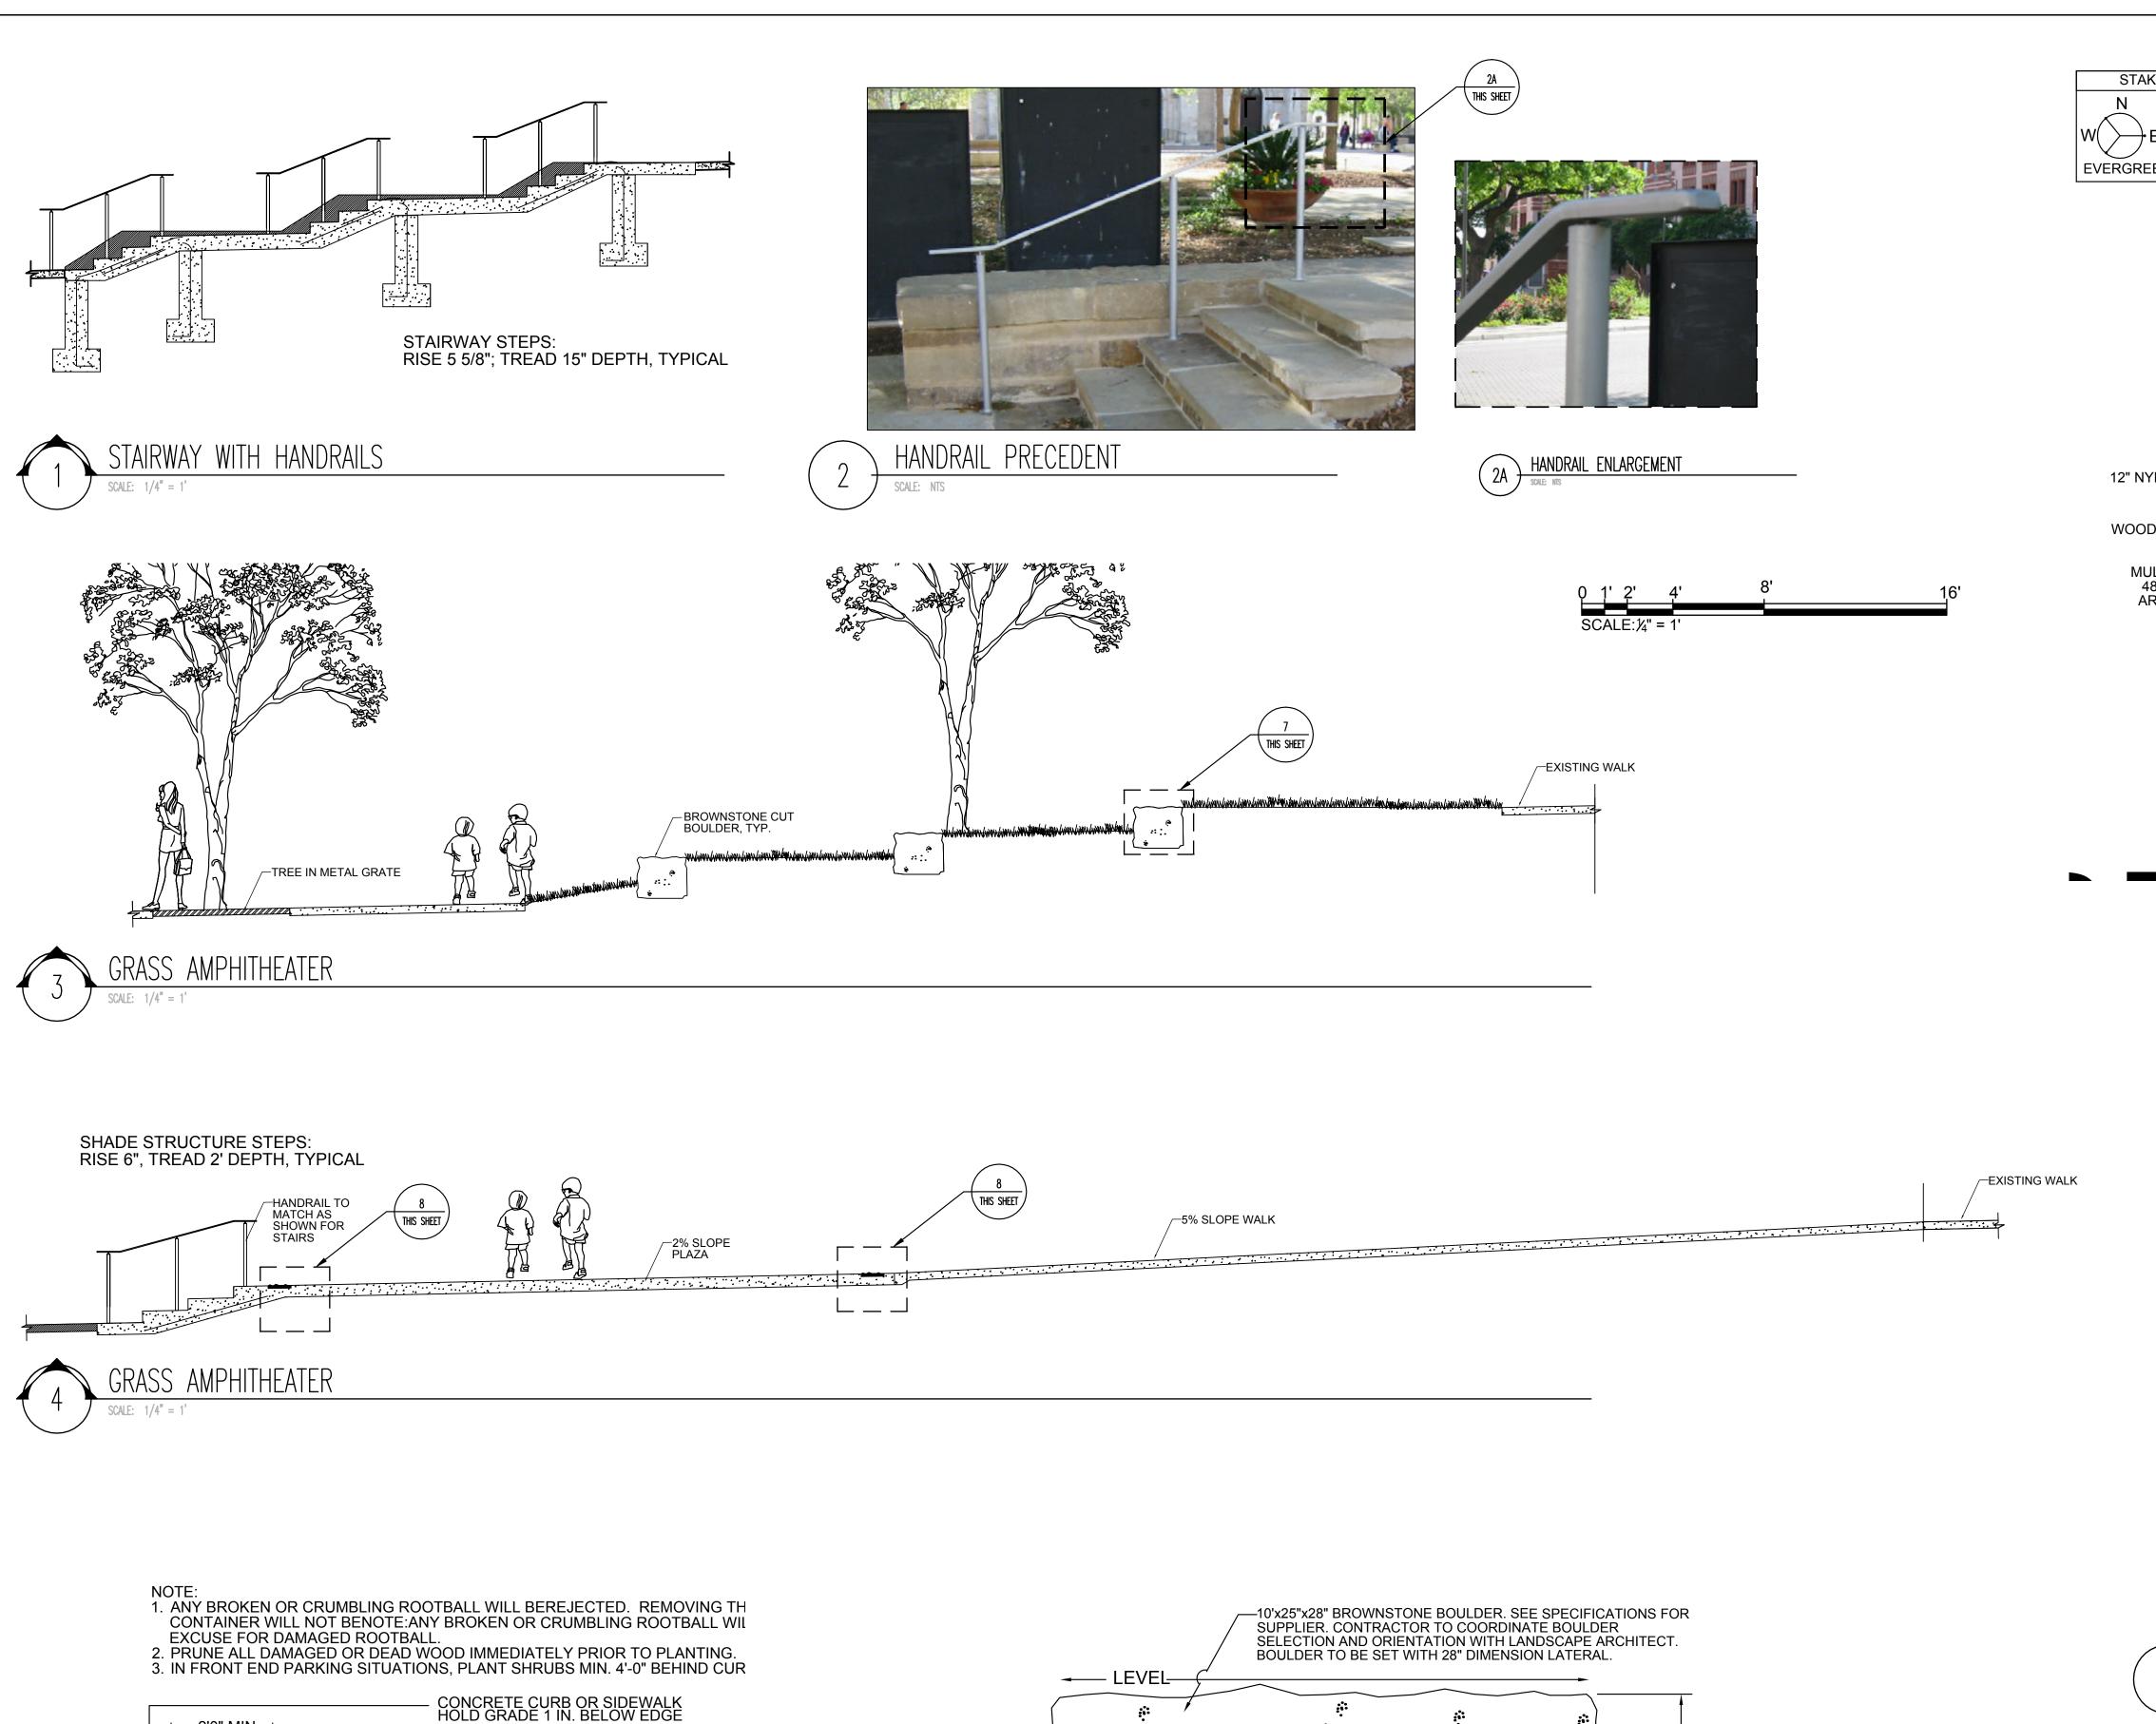

2'0"/MIN-

SET SHRUB 1 IN. HIGHER THAN THE GRADE AT WHICH IT GREW

FINISH GRADE (ALL JUNIPER PLANTS SHOULD BE PLANTED SO TOP OF ROOT MASS OCCURS AT FINISH GRADE OF MULCH LAYER)


LOOSEN SIDES OF PLANT PIT AND ROOT


- DIG PLANT PIT TWICE AS WIDE AS THE CONTAINER - SPECIFIED MULCH 4" DEEP

SPECIFIED BACKFILL MIXTURE

REMOVE CONTAINER

SHRUB PLANTING DETAIL, TYP.

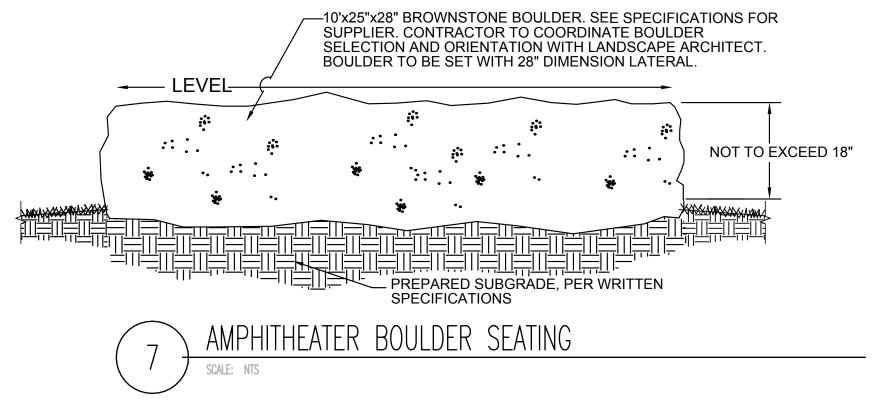

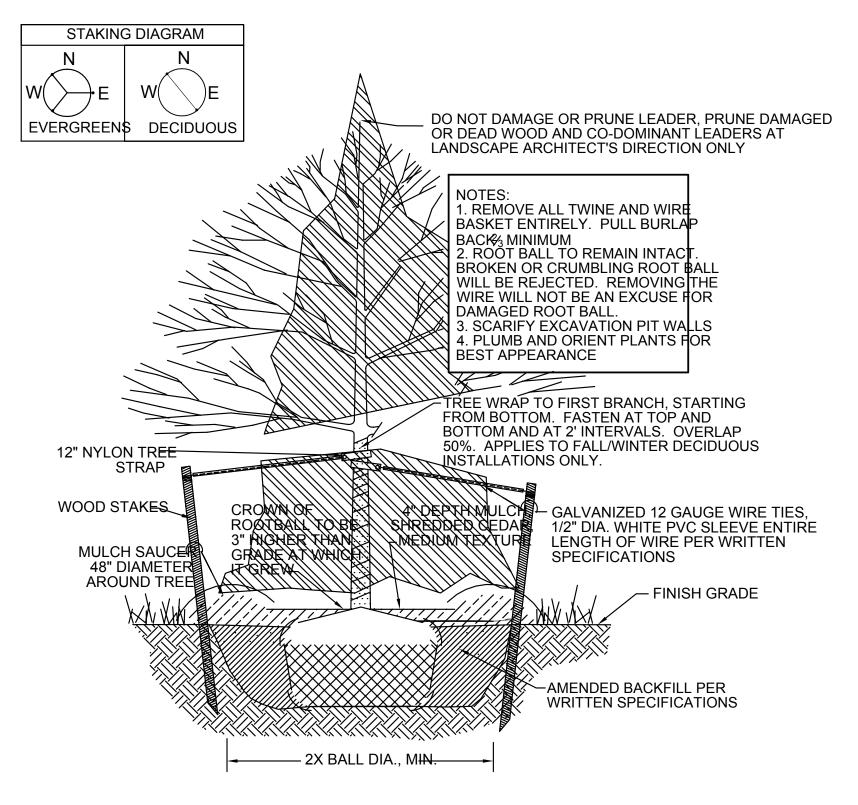






8 TRUNCATED DOME WARNING STRIP FOR SHADE STRUCTURE PLATFORM
8 SCALE: NTS

	DENVER PUBLIC SCHOOLS DEPARTMENT OF FACILITIES MANAGEMENT APPROVED CONTRACT DOCUMENT		CHECKED BY DATE 15 APRIL	JG JG L 2009		DETA		SHEET.		
			SAMUELS ELEMENTARY SCHOOL LEARNING LANDSCAPE 3985 S Vincennes Ct. Denver, CO 80237							
			SCHOOL DISTRICT		DEPARTMENT SITE NO. 148	OF FACILITIES NO.	MANAGEMENT	/ER, COL	ORADO	
NO.			DESCRIPTIO	ON OF	REVISION		AUTHORITY	MADE	APPR'I	
	04.15.09		50% CONSTRU	UCTION	DRAWINGS					

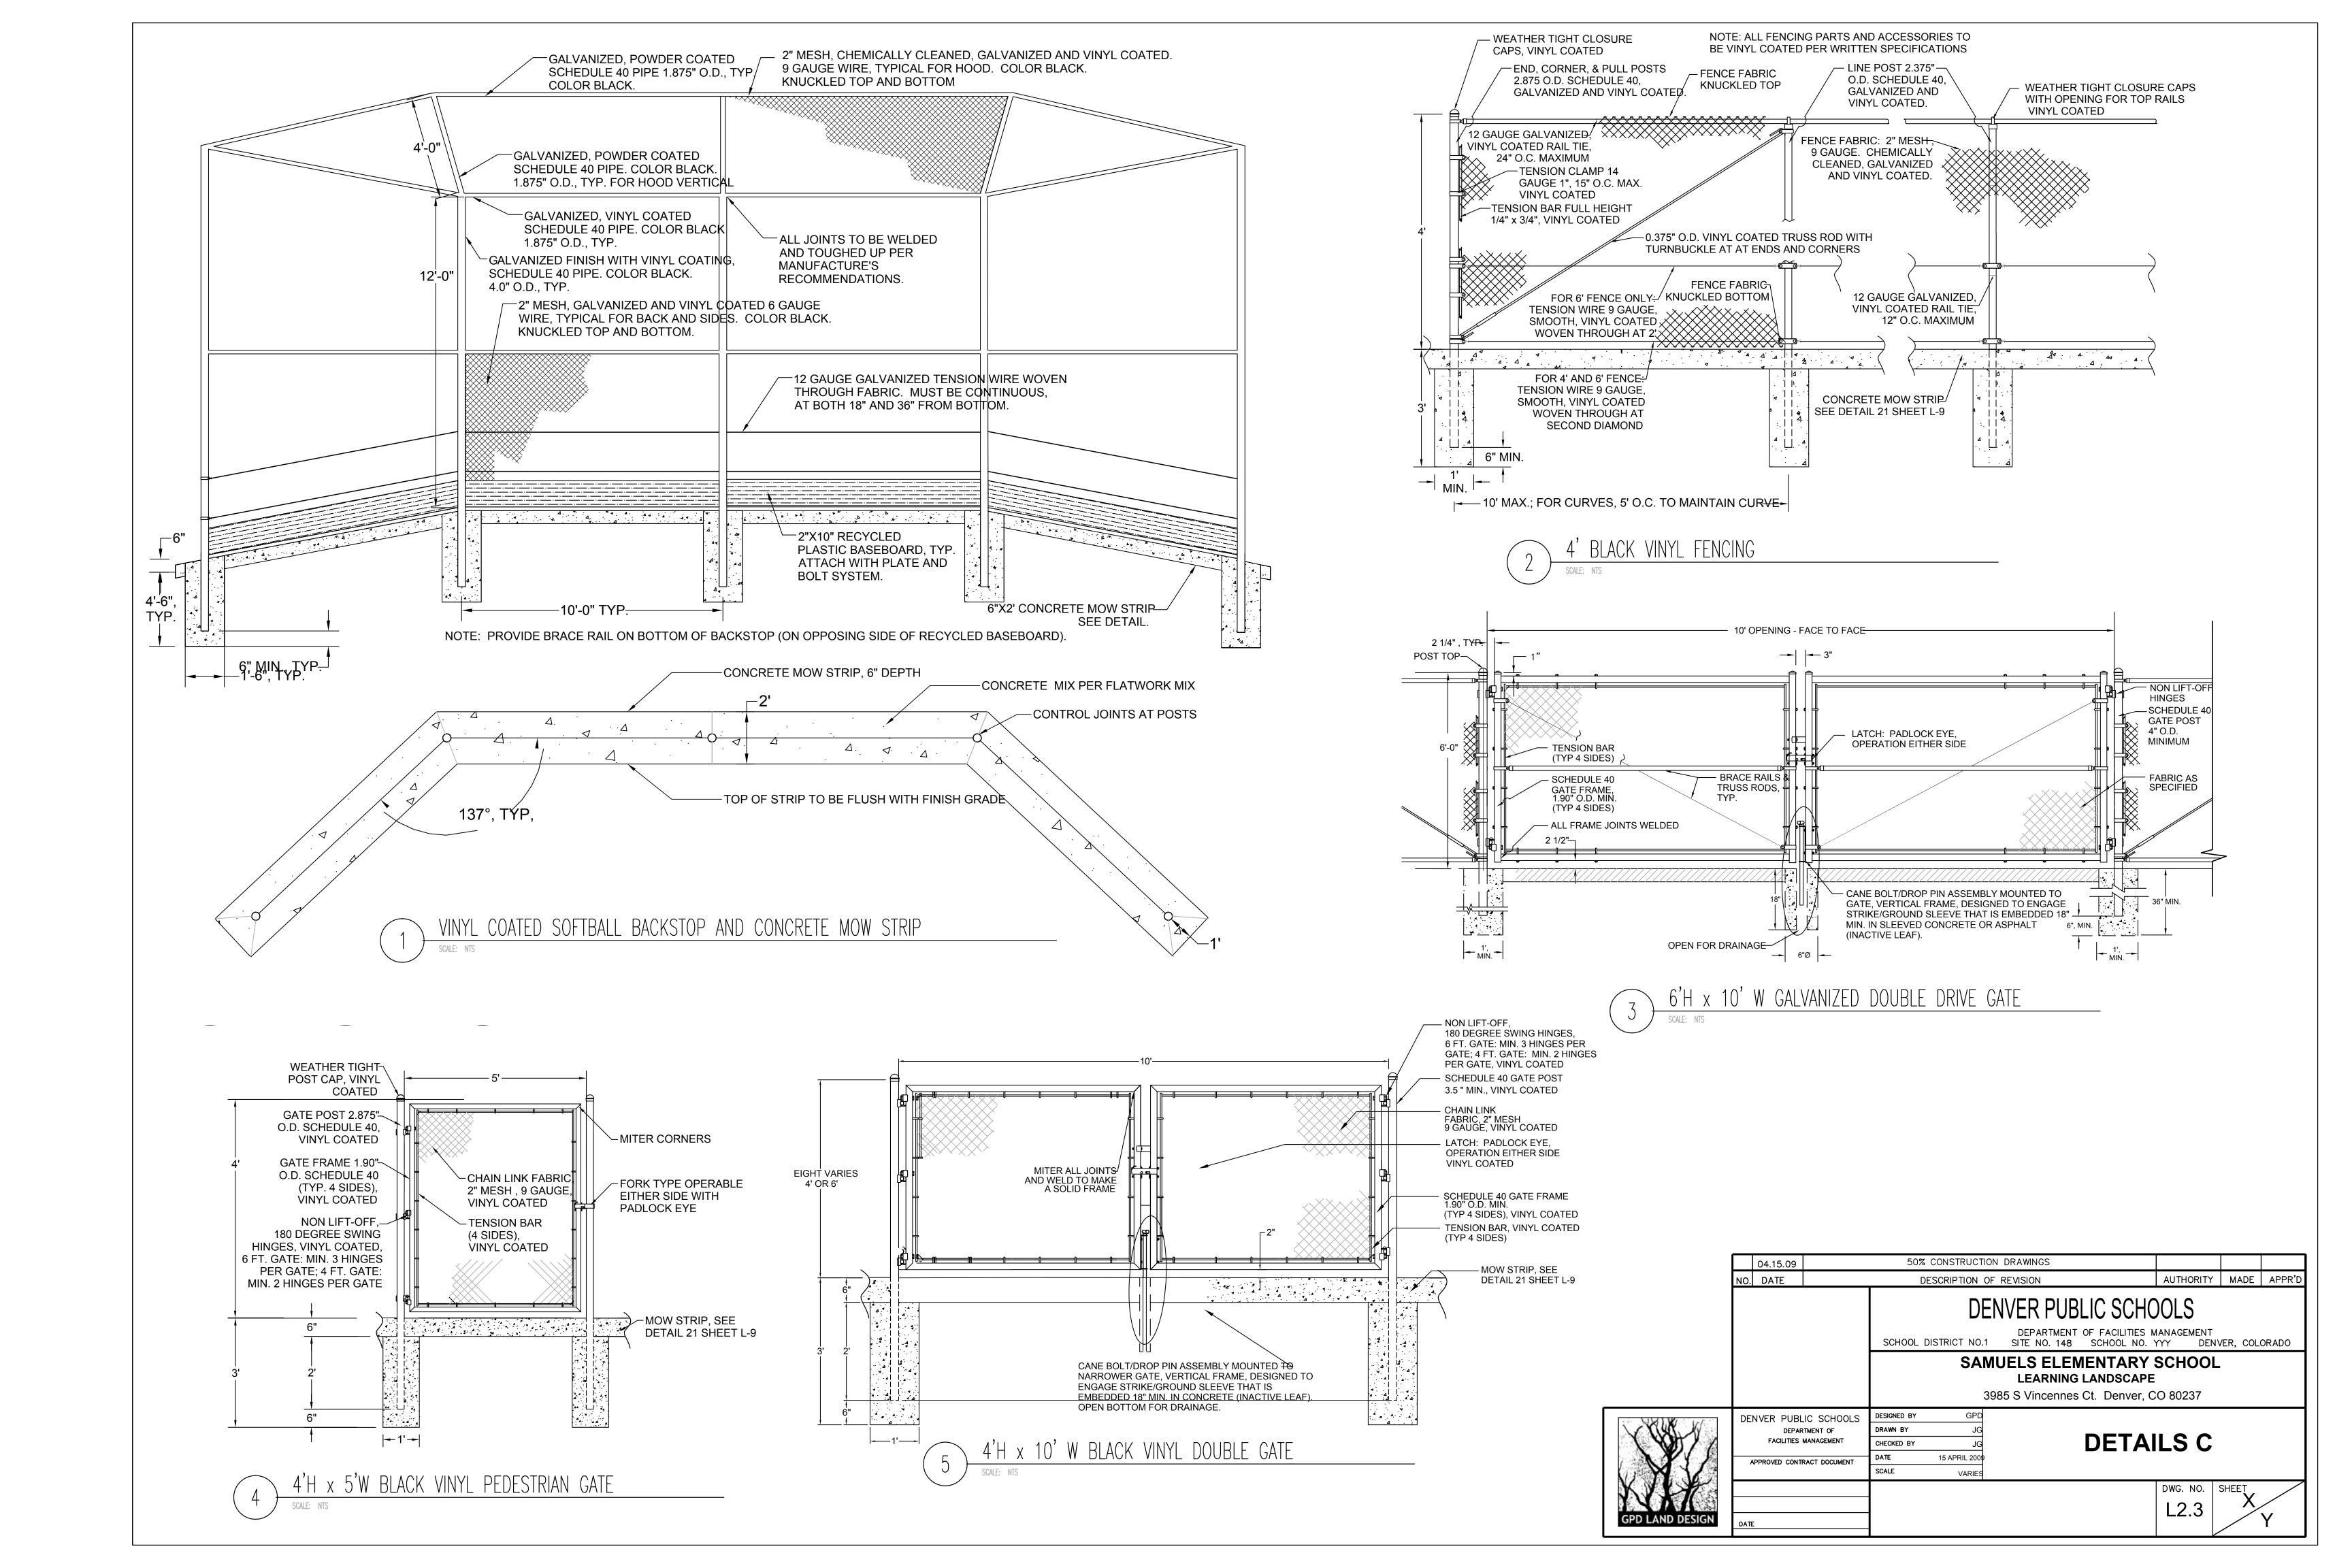

PRECEDENTS





PEDESTAL/ TOTEM

ENGRAVED BENCH





ENGRAVED BOULDER

ENGRAVED CONCRETE WALL





CONCRETE PEDESTAL

ENGRAVED STONE WALL





STEEL CUT OUT

OGRAPHY MARKERS PLAN

ANCHORAGE

UNITED STATES OF

AMERICA

2403mi 3867km

CLIMATE: SUBARCTIC

ANIMALS: BLACK BEAR,

GRIZZLY BEAR, MOOSE





DENVER

UNITED STATES OF

STARTING POINT

AMERICA

CLIMATE: SEMI-ARID

HIGH-DESERT

ANIMALS: BISON,

BIGHORN SHEEP,

WOLF, FOX, MOUNTAIN

LION



NEW YORK

UNITED STATES OF

1623mi 2612km

CLIMATE: HUMID

SUBTROPICAL

ANIMALS: BLACK BEAR,

WILD TURKEY, DEER,

MOSCOW

RUSSIAN FEDERATION

5494mi 8842km

CLIMATE: HUMID

ANIMALS: HARE,

GREAT EAGLE OWL,

SQUIRREL, FOX,

CONTINENTAL

BEAVER

AMERICA



MEXICO CITY

1439mi 2316km

CLIMATE: TEMPERATE/

HIGHLAND

ANIMALS: MEXICAN

GREY WOLF, OCELOT,

LIZARD, DONKEY,

MUMBAI

ANIMALS: BENGAL

TIGER, INDIAN

ELEPHANT, PEACOCK,

8376mi 13,480km

CLIMATE: TROPICAL

KING COBRA

PUMA, JAGUAR



3990mi 6421km

CLIMATE: DESERT &

SUBTROPICAL

ANIMALS: LLAMA,

VIZCACHA, DEER,

ANDEAN FOX

BEIJING

6363 mi 10240km

CLIMATE: HUMID

ANIMALS: GIANT

PANDA, SIBERIAN

TIGER, SNUB-NOSED

CONTINENTAL

GOLDEN MONKEY



BUENOS AIRES

ARGENTINA


5910 mi 9512km



CAPE TOWN SOUTH AFRICA 9320mi 14999km

CLIMATE: MEDITERRANEAN

ANIMALS: AFRICAN ELEPHANTS, AFRICAN LION, LEOPARD, CROCODILE, WILDEBEAST

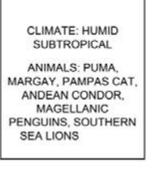

TOKYO

5814mi 9356km

CLIMATE: HUMID

ANIMALS: ALBATROSS,

SEROW, OTTER, GENJI

FIREFLY, IRIOMOTE

SUBTROPICAL

WILDCAT







SYDNEY

AUSTRALIA

8,315mi 13,382km

DEVIL, WOMBAT,

PLATYPUS, EMU

CUMATE: TEMPERATE



DESCRIPTION:

INTERESTING ANIMALS.

OF THE WORLD MAP ON THE PLAZA.

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3. THEY WILL BE ORIENTED ACCORDING TO NORTH ON THE SITE AND BY ALIGNING THE EQUATOR WITH THE EQUATOR

4. EACH MARKER WILL HAVE THE FOLLOWING INFORMATION: CITY, COUNTY, DISTANCE FROM DENVER, CLIMATE, AND


2. EACH MARKER WILL HAVE A DISTINCT FORM OF DISPLAY SUCH AS THE PRECEDENTS TO THE RIGHT.

DENVER PUBLIC SCHOOLS

SCHOOL DISTRICT NO.1 DEPARTMENT OF FACILITIES MANAGEMENT SITE NO. 148 SCHOOL NO. YYY DENVER, COLORADO

SAMUELS ELEMENTARY SCHOOL LEARNING LANDSCAPE

3985 S Vincennes Ct. Denver, CO 80237

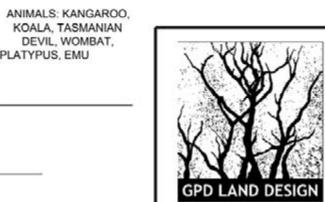

GPD	DESIGNED BY	DENVER PUBLIC SCHOOLS	
EG	DRAWN BY	DEPARTMENT OF	
JG	CHECKED BY	FACILITIES MANAGEMENT	
15 APRIL 2009	DATE	APPROVED CONTRACT DOCUMENT	
1" = 30'	SCALE		

1. GEOGRAPHY MARKERS TO BE LAID OUT ON THE SITE.

DETAILS D

GEOGRAPHY MARKERS INFORMATION BY CITY

CAIRO

EGYPT

6864mi 11,046km

CLIMATE: DESERT &

MEDITERRANEAN

ANIMALS: AOUDAD,

DORCAS, GAZELLE, FENNEC, NUBIAN IBEX

LONDON

UNITED KINGDOM

CLIMATE: TEMPERATE/

MARINE


ANIMALS: RED DEER,


FOX, RABBIT, BADGER, WEASEL, HEDGEHOG

4693mi 7553km


PRODUCED BY AN AUTODESK EDUCATIONAL PRODUCT



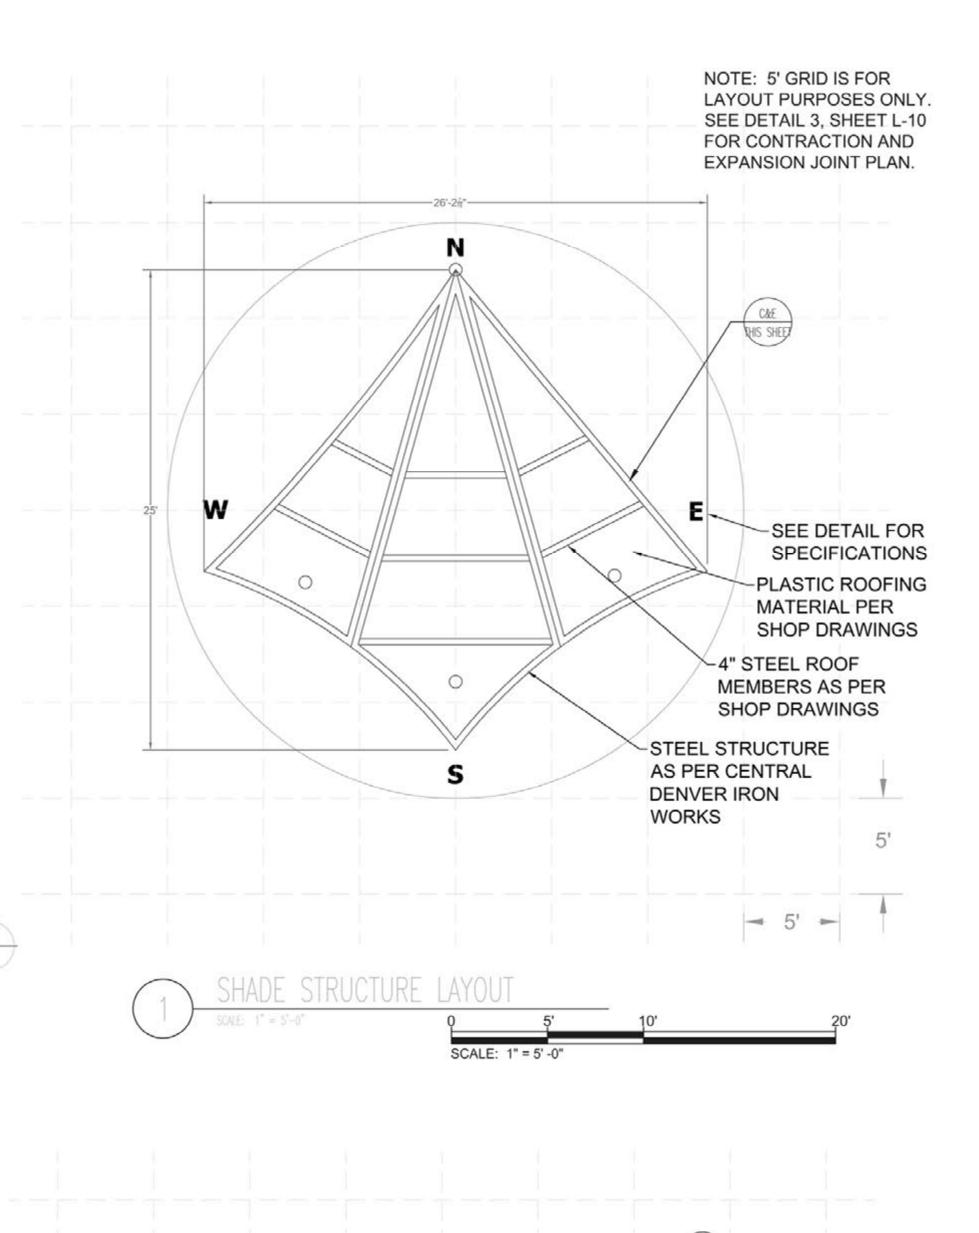

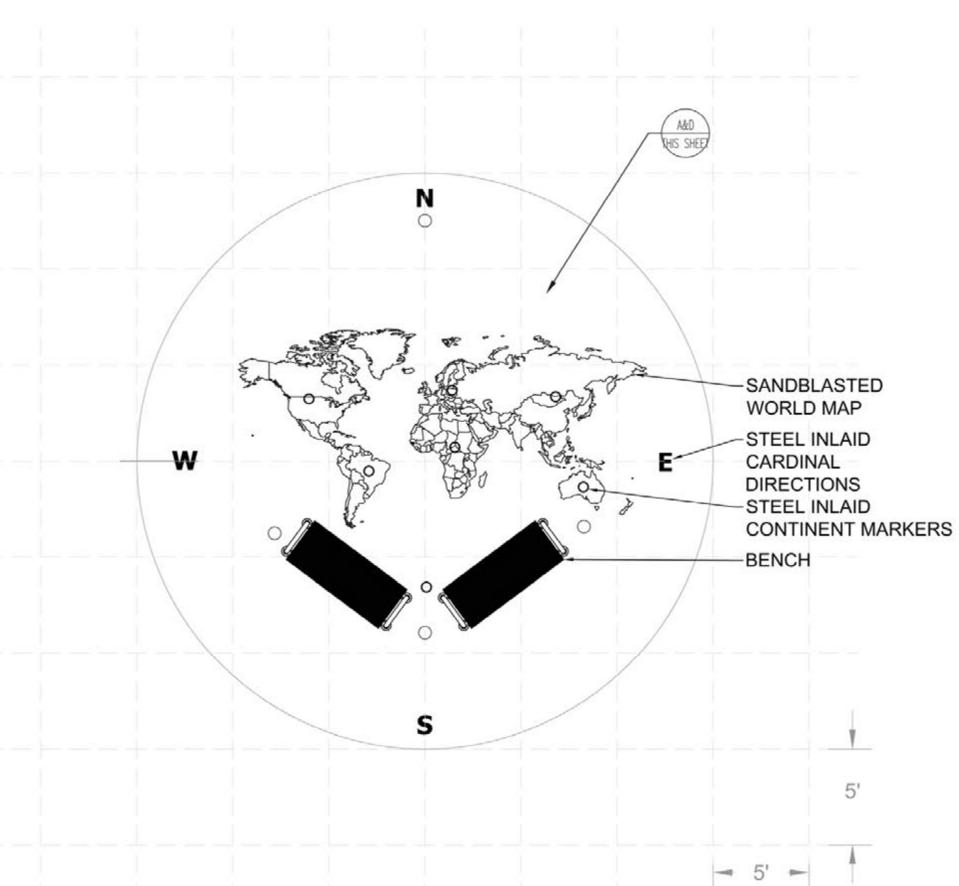


SHADE STRUCTURE PLAZA LAYOUT

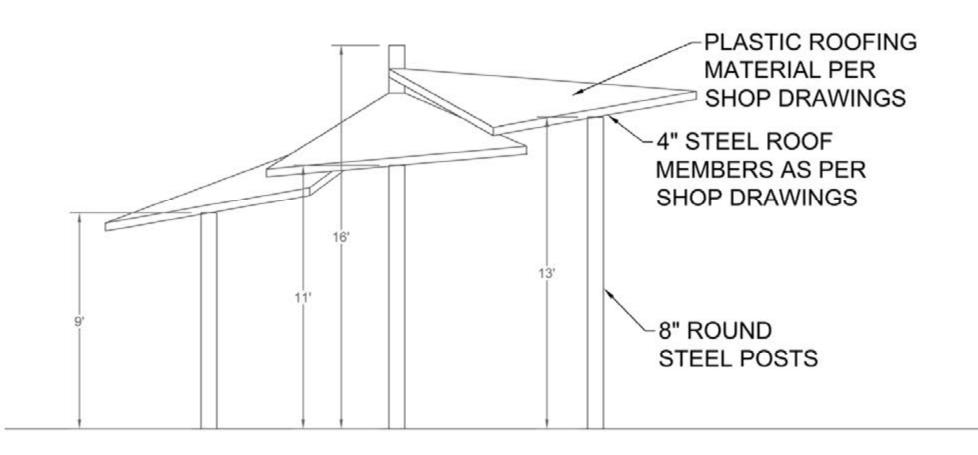


SEWN SS LETTERS, FONT: TAHOMA,




HEIGHT 12"

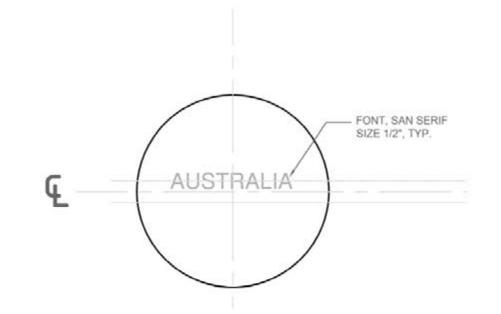


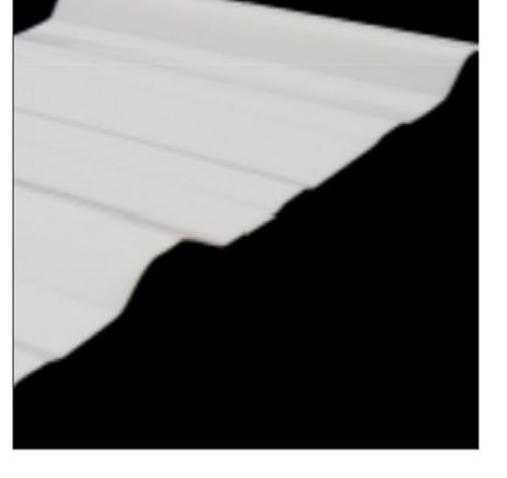

SABIC POLYMERSHAPES R-LIGHT* SERIES

XAMPLE STAINLESS STEEL ENGRAVED CITY DISKS - 6" DIAMETER

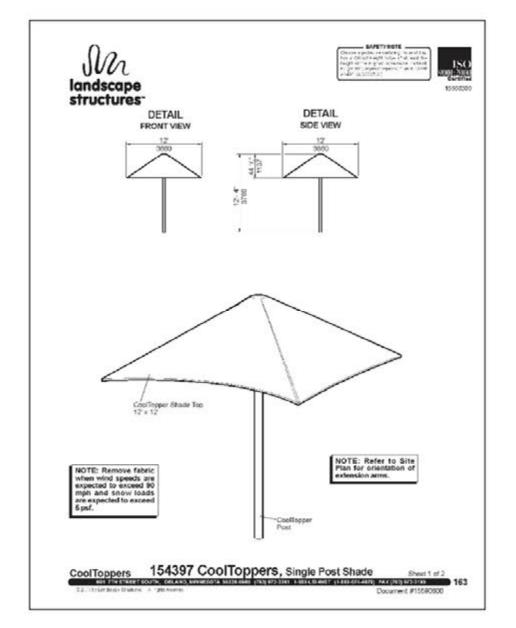

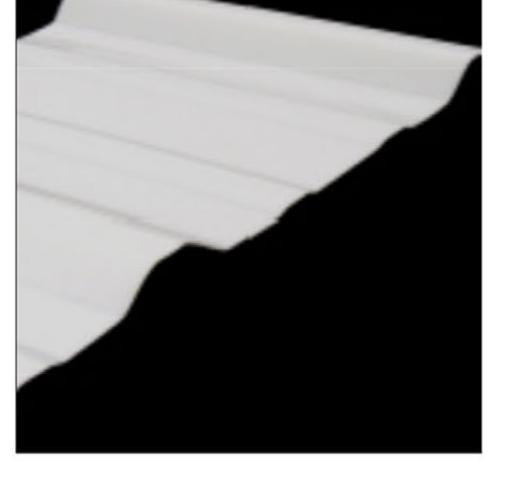

1. ALL EXPOSED VERTICAL CONCRETE TO HAVE CLASS 1

— TACK WELD, TYP.

SECTION - DISKS, PLAQUES, LETTERS & STAR

CONCRETE WORK NOTES:

 $-\frac{1}{4}$ " Ø STEEL PIN WITH $\frac{3}{4}$ " Ø HEAD TO HOLD STEEL PLATE IN CONCRETE,

PLAQUE. AMOUNT TO BE USED EQUALS WHAT IS NECESSARY TO KEEP PLAQUE FLUSH IN CONCRETE.

DETERMINED ACCORDING TO SIZE OF

TYP. NUMBER OF PINS TO BE

- 2. ALL CONCRETE TO BE REINFORCED PER DRAWINGS AND
 - WRITTEN SPECIFICATIONS. 3. ALL PIT INTERIORS TO RECEIVE 1" RADIUS TOOLED
 - BULLNOSE.

-RECESS FOOTING 6" BELOW

PATCH WITH CONCRETE.

(EMBED 1' MINIMUM)

36" DIAMETER x 4'-6" DEEP PIER AT COLUMNS

-5-#3 TIES. 3@ TOP, 1@

BOTTOM, 1@ MID-HEIGHT

COMPACTED

-#3 TIES

BACKFILL

BASE PLATE W/ ANCHOR

BOLTS (ACQUIRE FROM

CENTRAL DENVER IRONWORKS)

4-#4 VERTICALS

FINAL ASPHALT GRADE. BACK

ANCHOR BOLTS SUPPLIED BY CENTRAL DENVER IRONWORKS

____ 30" ____

30" DIAMETER

SONITUBE

BLOCK OUT

EL. 40.08~

SUBGRADE -

1/4" STAINLESS STEEL, BRUSHED FINISH

- 4. JOINTS TO BE PLACED PER WRITTEN SPECIFICATIONS AND DRAWINGS.
- 5. ADJACENT COLORED CONCRETE POURS TO BE JOINED USING DOWEL DETAIL 7 SHEET L-9.

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DESCRIPTION OF REVISION

DENVER PUBLIC SCHOOLS

SCHOOL DISTRICT NO.1 DEPARTMENT OF FACILITIES MANAGEMENT SITE NO. 148 SCHOOL NO. YYY DENVER, COLORADO

SAMUELS ELEMENTARY SCHOOL

LEARNING LANDSCAPE 3985 S Vincennes Ct. Denver, CO 80237



NOTES:

SEE LAYOUT PLAN FOR ADDITIONAL

AUTOCAD FILE AVAILABLE.

NO. DATE


DIMENSIONS RELATIVE TO FIXED OBJECTS.

ALL TEXT AND IMAGERY IS LASER CUTOUT.


DENVER PUBLIC SCHOOLS	DESIGNED BY	EG			
DEPARTMENT OF	DRAWN BY	3			
FACILITIES MANAGEMENT	CHECKED BY				
APPROVED CONTRACT DOCUMENT	DATE	15 APRIL 2			
A THOSE SOUTH OF DOCUMENT	SCALE				

DETAILS E


AUTHORITY MADE APPR'D

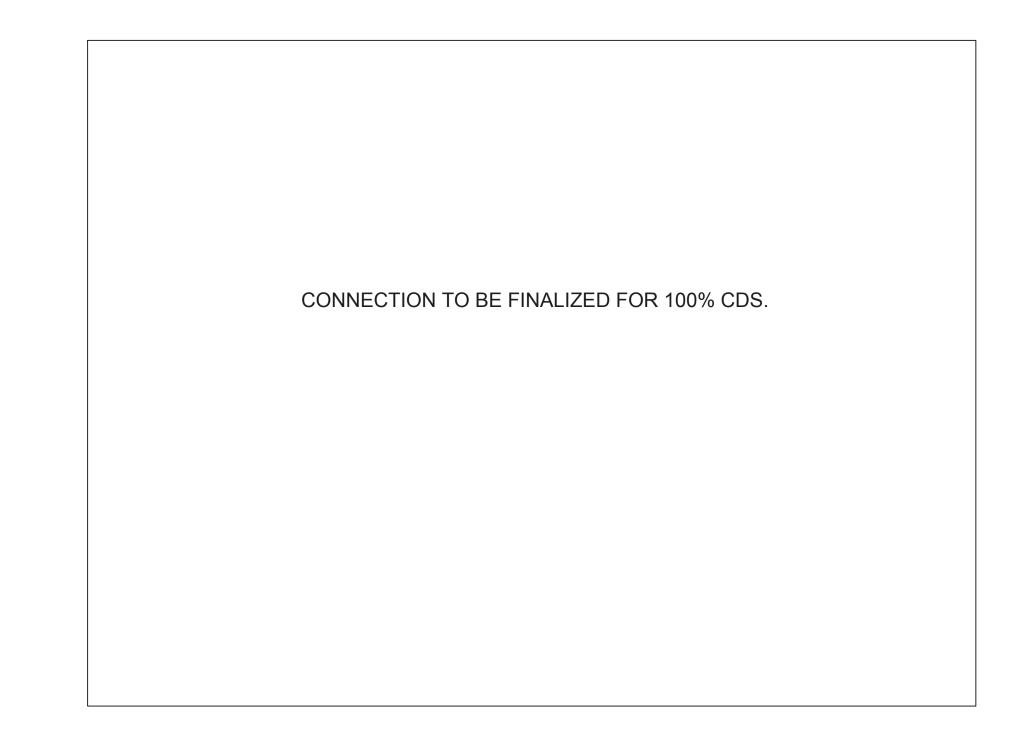



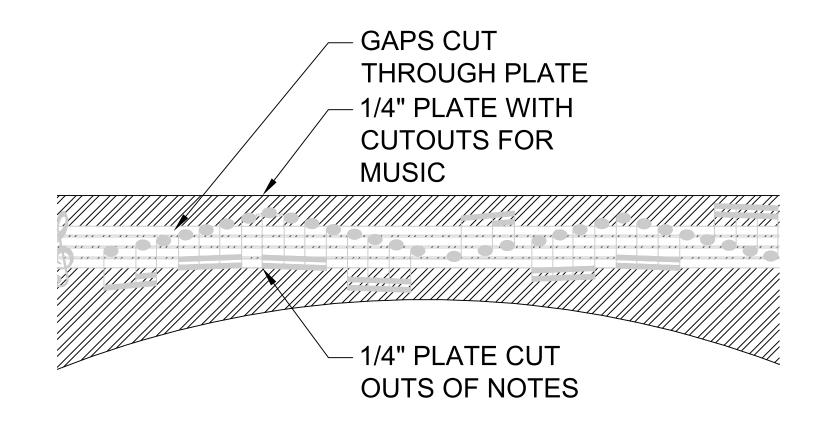



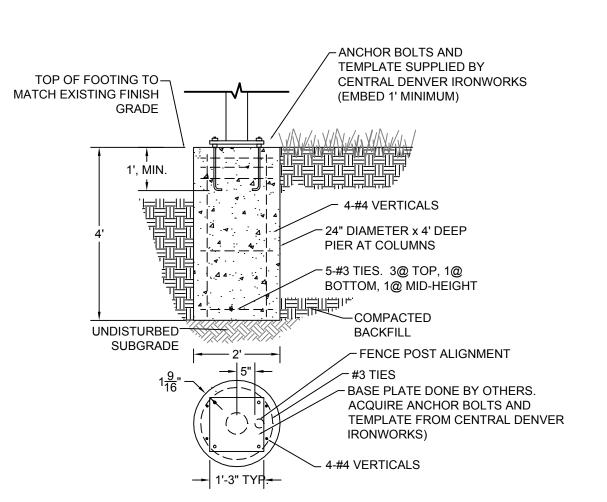

GATEWAY FOOTING

B FOOTING DETAIL

SCALE: NTS

NOTES 1. ALL ST

- ALL STRUCTURES TWO COATS POWDER COAT PAINT AND CLEAR COAT, ANTI-GRAFITTI FINISH.
- 2. ALL ROUGH EDGES AND WELDSTO BE GROUND SMOOTH.

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						JUELS ELEME LEARNING I 3985 S Vincennes C	LANDSCAPE			
** .	DEN	NVER PUBL	IC SCHOOLS	DESIGNED BY	EG/JG					
		DEPAR	TMENT OF	DRAWN BY	EG					
		FACILITIES I	CILITIES MANAGEMENT	CHECKED BY	JG		DETAI	LS F		
2/8	A	PPROVED CONTE	RACT DOCUMENT	DATE	15 APRIL 2009					
				SCALE	VARIES					
								DWG. NO.	SHEEŢ	

